

WORCESTER COUNTY DEPARTMENT OF PUBLIC WORKS

BERLIN HOMEOWNER CONVENIENCE CENTER BULKHEAD REPAIR

WORCESTER COUNTY, MARYLAND



EA Engineering, Science, and
Technology, Inc., PBC

11200 Racetrack Road, Unit A101
Ocean Pines, Maryland 21811
(410) 641-5341


www.eaest.com

ABBREVIATIONS


AC	ACRES
APPRX	APPROXIMATELY
BLDG	BUILDING
BW	BOTTOM OF WALL
CATV	CABLE TELEVISION
COMM	COMMUNICATIONS
CONC	CONCRETE
CL	CENTERLINE
CLR	CLEARANCE
CY	CUBIC YARD
ELEV	ELEVATION
ESC	EROSION AND SEDIMENT CONTROL
EX/EXIST	EXISTING
FL	FLOWLINE
FT	FEET
INV	INVERT
LF	LINEAR FOOT
L.O.D	LIMITS OF DISTURBANCE
m.l.	MILE
MOSH	MARYLAND OCCUPATIONAL SAFETY AND HEALTH
N/A	NOT APPLICABLE
NAD 83	NORTH AMERICAN DATUM OF 1983
NAVD 88	NORTH AMERICAN VERTICAL DATUM OF 1988
NO.	NUMBER
O.C.	ON CENTER
O.C.E.W.	ON CENTER EACH WAY
OHE	OVERHEAD ELECTRIC
PR	PROPOSED
SCH	SCHEDULE
SD	STORM DRAIN
SF	SQUARE FEET
SWM	STORMWATER MANAGEMENT
TW	TOP OF WALL
TYP	TYPICAL
UGND/UG	UNDERGROUND
W	WITH
WSEL	WATER SURFACE ELEVATION

GENERAL NOTES:

- TOPOGRAPHIC SURVEY PERFORMED BY RUSSELL T. HAMMOND SURVEYING, LLC IN OCTOBER 2024, SUPPLEMENTED IN JUNE 2025, AND PROVIDED TO EA ENGINEERING, SCIENCE, & TECHNOLOGY, INC., PBC FOR PLAN PRODUCTION.
- PARTIAL BOUNDARY DETERMINATION SURVEY PERFORMED BY RUSSELL T. HAMMOND SURVEYING, LLC. IN JUNE 2025.
- UTILITY INFORMATION IS FOR THE CONVENIENCE OF THE CONTRACTOR ONLY. THE CONTRACTOR SHALL LOCATE AND TAKE THE NECESSARY PRECAUTIONS TO LOCATED AND PROTECT THE EXISTING UTILITIES. CONTRACTOR SHALL NOTIFY "MISS UTILITY" AT LEAST 48 HOURS PRIOR TO EXCAVATION.
- THIS PROJECT IS EXEMPT FROM WORCESTER COUNTY FOREST CONSERVATION LAW. THE PROJECT DOES NOT HAVE QUALIFYING FORESTED AREA WITHIN THE LIMIT OF DISTURBANCE AS DEFINED BY MARYLAND AND WORCESTER COUNTY CODE (NR 1-402(B)).
- CONTRACTOR SHALL BE SOLELY RESPONSIBLE FOR THE MEANS, METHODS, TECHNIQUES, AND PROCEDURES, UTILIZED FOR THE CONSTRUCTION UNDER THE SCOPE OF WORK. CONTRACTOR SHALL BE RESPONSIBLE FOR SAFETY OF THE PUBLIC AND CONTRACTOR'S EMPLOYEES. THE CONTRACTOR SHALL BE SOLELY RESPONSIBLE TO CARRY OUT THE WORK IN ACCORDANCE WITH THE CONTRACT DOCUMENTS AND STANDARD CONSTRUCTION PRACTICES.
- FAILURE TO MENTION SPECIFICALLY ANY WORK WHICH WOULD NORMALLY BE REQUIRED TO COMPLETE THIS PROJECT SHALL NOT RELIEVE THE CONTRACTOR FROM PERFORMING SUCH WORK.
- ALL WORK ON THIS PROJECT SHALL BE PERFORMED IN ACCORDANCE WITH THE REQUIREMENTS SET FORTH BY WORCESTER COUNTY STANDARDS.
- ALL DIMENSIONS, LOCATIONS, AND ELEVATIONS OF EXISTING STRUCTURES SHOWN ON THE CONTRACT DRAWINGS SHALL BE VERIFIED IN THE FIELD BY THE CONTRACTOR. ALL DISCREPANCIES SHALL BE BROUGHT TO THE ATTENTION OF THE ENGINEER BEFORE PROCEEDING WITH WORK.
- ALL ASPECTS OF CONSTRUCTION AND EQUIPMENT INSTALLATION SHALL BE PERFORMED / INSTALLED PLUM AND TRUE AND SHALL CONFORM TO THE PRACTICES OF GOOD WORKMANSHIP.
- MATERIAL DEMOLISHED/SALVAGED DURING CONSTRUCTION SHALL BECOME THE CONTRACTOR'S PROPERTY UNLESS OTHERWISE NOTED ON THE PLANS AND/OR SPECIFICATIONS.
- THE CONTRACTOR SHALL TAKE NECESSARY PRECAUTIONS CONCERNING SAFETY AND PRESERVATION OF EXISTING UTILITIES ADJACENT TO ANY WORK AND IS RESPONSIBLE FOR THE PROTECTION OF EXISTING STRUCTURES (BELOW GRADE AND ABOVE GRADE) DURING THE COURSE OF DEMOLITION AND CONSTRUCTION. ANY DAMAGE CAUSED BY THE CONTRACTOR SHALL BE REPAIRED IMMEDIATELY AND THE COSTS OF SUCH REPAIR SHALL BE BORNE BY THE CONTRACTOR.
- CONTRACTOR SHALL TAKE EVERY MEASURE TO PREVENT ANY AND ALL DAMAGE TO NEIGHBORING PROPERTIES. CONTRACTOR IS RESPONSIBLE FOR ANY AND ALL SUCH DAMAGE AND WILL REPAIR AND / OR REPLACE ANY OBJECT, PLANT OR PIECE OF PROPERTY TO ORIGINAL STATE ON ADJACENT PROPERTIES THAT IS DAMAGED IN ANY WAY DUE TO THIS CONSTRUCTION.
- ALL WORK SHALL BE COORDINATED WITH WORCESTER COUNTY DEPARTMENT OF PUBLIC WORKS. CONTRACTOR SHALL PROVIDE FOR AND MAINTAIN TRAFFIC ACCESS TO THE ADJACENT PROPERTY OWNERS AT ALL TIMES.
- THE CONTRACTOR IS RESPONSIBLE FOR KEEPING THE CONSTRUCTION SITE SECURE AT ALL TIMES.
- JOB SITE SAFETY SHALL BE SOLELY THE RESPONSIBILITY OF THE CONTRACTOR.
- CONTRACTOR IS RESPONSIBLE FOR PERFORMING ALL WORK IN ACCORDANCE WITH STATE AND FEDERAL CONFINED SPACE SAFETY REGULATIONS AS REQUIRED.
- CONTRACTOR SHALL BE RESPONSIBLE FOR RESTORATION OF SURFACES IN ALL DISTURBED AREAS.
- ANY AND ALL IMPROVEMENTS, SUCH AS ASPHALT OR CONCRETE PAVEMENT, SOD, ETC., IF DAMAGED, SHALL BE RESTORED TO ITS ORIGINAL CONDITION BY THE CONTRACTOR.
- THE CONTRACTOR SHALL FIELD VERIFY ALL DIMENSIONS AND ELEVATIONS PRIOR TO PROCEEDING WITH CONSTRUCTION.
- THE CONTRACTOR SHALL PROVIDE SURVEY CONSTRUCTION STAKEOUT FOR ALL NECESSARY LINE, GRADES, AND ELEVATIONS OF THE PROPOSED FACILITIES.
- THE CONTRACTOR SHALL MAINTAIN AN "AS-BUILT" DRAWING RECORD OF THE PROPOSED CONSTRUCTION. THE CONTRACTOR SHALL RECORD ALL DEVIATIONS FROM THE CONTRACT DOCUMENTS AS THEY OCCUR, TO CLEARLY DEPICT HOW WORK WAS ACTUALLY CONSTRUCTED. PARTICULAR ATTENTION SHALL BE GIVEN TO ACCURATE RECORDINGS OF CONCEALED WORK. THE "AS-BUILT" RECORD SHALL INCLUDE DESCRIPTIONS, DRAWINGS, SKETCHES, MARKED PRINTS, AND SIMILAR DATA SHALL BE MAINTAINED AT THE JOB SITE AND SHALL BE KEPT CURRENT ON A DAILY BASIS AS WORK PROGRESSES. ALL "AS-BUILT" DRAWINGS AND RELATED DATA SHALL BE SUBJECT TO REGULAR SURVEILLANCE BY THE OWNER'S ON-SITE REPRESENTATIVE.
- MAINTENANCE SHALL BE PERFORMED AS NECESSARY TO ENSURE STABILIZED AREAS CONTINUOUSLY MEET APPROPRIATE REQUIREMENTS OF THE 2011 MARYLAND STANDARDS AND SPECIFICATIONS FOR SOIL AND EROSION AND SEDIMENT CONTROL.
- APPROVED PLANS FOR EROSION AND SEDIMENT CONTROL REMAIN VALID FOR 3 YEARS FROM THE DATE OF APPROVAL.

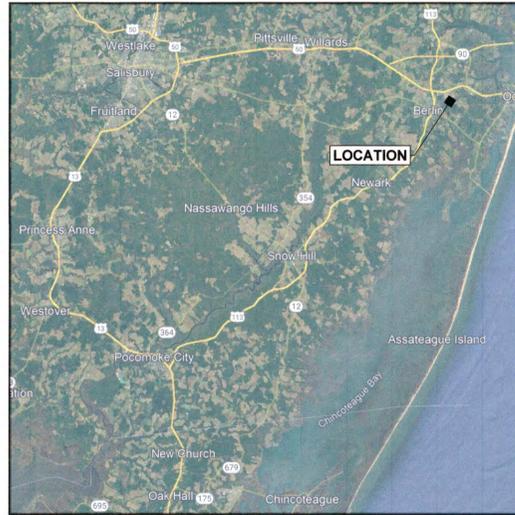

LOCATION MAP
SCALE: 1" = 6 mi.

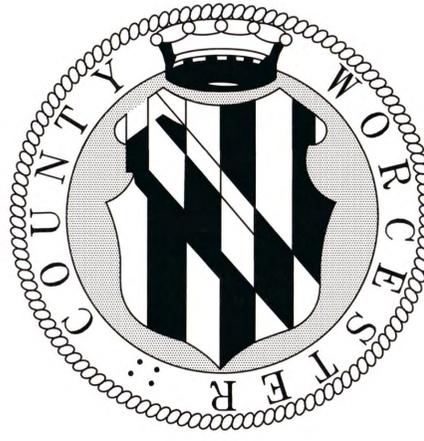

SHEET LIST

DRAWING NO.	SHEET NO.	DRAWING TITLE
G-001	1	TITLE SHEET
C-101	2	EXISTING CONDITIONS AND DEMOLITION PLAN
C-102	3	PROPOSED SITE LAYOUT
C-103	4	EROSION AND SEDIMENT CONTROL PLAN
C-501	5	DETAILS
C-502	6	EROSION AND SEDIMENT CONTROL NOTES AND DETAILS
C-503	7	EROSION AND SEDIMENT CONTROL NOTES
S1.1	8	STRUCTURAL PLAN, DETAILS, AND NOTES
S2.1	9	SECTIONS AND DETAILS
E-101	10	ELECTRICAL SITE PLAN, NOTES, ABBREVIATIONS, AND LEGEND
E-102	11	ELECTRICAL DETAILS AND ONE-LINE DIAGRAM



VICINITY MAP
SCALE: 1" = 700'

S.W.M. Plan Approval
Worcester County Environmental Programs
Snow Hill, MD 21863
Approved by: *[Signature]*
Date: 11/20/25
THIS APPROVAL EXPIRES IN TWO (2) YEARS.

WAIVER
RECOMMENDED

PROJECT AND SITE DATA

- OWNER:** COUNTY COMMISSIONERS OF WORCESTER COUNTY, MARYLAND
1 WEST MARKET STREET, ROOM 1103
SNOW HILL, MARYLAND 21863
CONTACT: MR. DALLAS BAKER, P.E.
PHONE: 410-632-5623 EXT. 2300
EMAIL: DBAKER@CO.WORCESTER.MD.US
- APPLICANT:** WORCESTER COUNTY DEPARTMENT OF PUBLIC WORKS
6113 THIMMONS ROAD
SNOW HILL, MARYLAND 21863
CONTACT: MR. DALLAS BAKER, P.E.
PHONE: (410) 632-5623 EXT. 2300
EMAIL: DBAKER@CO.WORCESTER.MD.US
- ENGINEER:** EA ENGINEERING, SCIENCE, AND TECHNOLOGY, INC. PBC
11200 RACETRACK ROAD, UNIT 101A
OCEAN PINES, MARYLAND 21811
CONTACT: STEVEN LEMASTERS, P.E.
PHONE: 410-641-5341
EMAIL: SLEMASTERS@EAEST.COM
- SITE ADDRESS:** 9696 MILL HAVEN ROAD, BERLIN, MD 21811
- PROPERTY:** TAX MAP 25, PARCEL 0423, GRID 0001, AREA= 24.99 ACRES
- FLOODPLAIN:** ZONE X (UNSHADED); AREAS DETERMINES TO BE OUTSIDE THE 0.2% ANNUAL CHANCE FLOODPLAIN PER FIRM PANEL 24047C0154H LAST REVISED JULY 16, 2015. PANEL 154 OF 450.
- SOILS PRESENT:** UzB - UDORTHERTS, LOAMY (HSG C)
FmB - FORT MOTT LOAMY SAND (HSG A)
- PROPOSED L.O.D.:** 38,860 SF OR 0.892 ACRES
- ESTIMATED CUT VOLUME:** 235 CY
- ESTIMATED FILL VOLUME:** 165 CY
- FOREST CONSERVATION IS NOT REQUIRED.
- NO PART OF THE PROJECT RESIDES WITHIN THE CRITICAL AREA BUFFER.
- NO WETLANDS WILL BE DISTURBED AS A PART OF THE PROJECT.

CONSULTANTS CERTIFICATION

I CERTIFY THAT THIS PLAN OF EROSION AND SEDIMENT CONTROL REPRESENTS A PRACTICABLE AND WORKABLE PLAN BASED ON MY PERSONAL KNOWLEDGE OF THE SITE, AND THIS PLAN WAS PREPARED IN ACCORDANCE WITH THE REQUIREMENTS OF APPLICABLE SOIL EROSION AND SEDIMENT CONTROL CODES. I HAVE REVIEWED THIS EROSION AND SEDIMENT CONTROL PLAN WITH THE OWNER/DEVELOPER.

[Signature] 11/12/2025
STEVEN LEMASTERS, P.E. DATE
MD P.E. NO. 55422

CERTIFICATE OF COMPLIANCE

I HEREBY CERTIFY THAT I HAVE INSPECTED THIS SITE AND THAT DRAINAGE ONTO THIS SITE FROM OTHER UPGRADE PROPERTIES, AND FROM THIS SITE ONTO OTHER DOWNGRADE PROPERTIES HAS BEEN ADDRESSED IN SUBSTANTIAL ACCORDANCE WITH APPLICABLE CODES.

[Signature] 11/12/2025
STEVEN LEMASTERS, P.E. DATE
MD P.E. NO. 55422

OWNER/DEVELOPER CERTIFICATION

CERTIFICATION BY THE OWNER OR DEVELOPER THAT ANY CLEARING, GRADING, CONSTRUCTION, OR DEVELOPMENT WILL BE DONE PURSUANT TO THE APPROVED EROSION AND SEDIMENT CONTROL PLAN, INCLUDING INSPECTING AND MAINTAINING CONTROLS, AND THAT THE RESPONSIBLE PERSONNEL INVOLVED IN THE CONSTRUCTION PROJECT WILL HAVE A CERTIFICATE OF TRAINING AT A MARYLAND DEPARTMENT OF THE ENVIRONMENT (MDE) APPROVED TRAINING PROGRAM FOR THE CONTROL OF EROSION AND SEDIMENT PRIOR TO THE BEGINNING OF THE PROJECT. ADDITIONALLY, THE OWNER OR DEVELOPER SHALL CERTIFY RIGHT OF ENTRY FOR PERIODIC ON-SITE EVALUATION BY THE APPROPRIATE ENFORCEMENT AUTHORITY AND/OR MDE.

[Signature] 11/12/25
OWNER SIGNATURE DATE
Dallas Baker Jr.

Dallas Baker Jr.
PRINTED NAME
COUNTY COMMISSIONERS OF WORCESTER COUNTY, MARYLAND
1 WEST MARKET STREET
SNOW HILL, MARYLAND 21863

Sediment Control Plan Approval
Worcester Soil Conservation District
Snow Hill, MD 21863
Approved by: *[Signature]*
Date: 11/20/25

SUMMARY OF WORK

THE PROJECT GENERALLY CONSISTS OF THE FOLLOWING WORK ITEMS:

- COORDINATION WITH COUNTY TO MAINTAIN OPERATIONS DURING CONSTRUCTION ACTIVITIES
- PHASE CONSTRUCTION OF WALL CONSTRUCTION TO MAINTAIN OPERATIONS
- DEMOLITION OF EXISTING TIMBER WALLS, CONCRETE PADS, AND OTHER ANCILLARY ITEMS AS SHOWN IN THE CONTRACT DOCUMENTS
- CONSTRUCTION OF PROPOSED REINFORCED CONCRETE WALL AND CONCRETE PADS
- REGRAVING OF RAMP TO LOWER OVERALL WALL HEIGHT
- FULL DEPTH PAVEMENT TO LIMITS SHOWN
- ASPHALT OVERLAY AND BUTT JOINT TIE INTO EXISTING PAVEMENT
- REFRESH OF STONE ACCESS
- INSTALLATION AND MAINTENANCE OF EROSION AND SEDIMENT CONTROLS
- ELECTRICAL SERVICE UPGRADE
- CONNECTION OF ALL ELECTRICAL COMPONENTS
- ANY WORK THAT REQUIRES BOTH TRAFFIC LANES TO BE INOPERABLE SHALL BE PERFORMED ON WEDNESDAYS WHEN THE SITE IS CLOSED TO THE PUBLIC

THIS FACILITY IS TO BE CONSTRUCTED IN ACCORDANCE WITH THESE PLANS ARE APPROVED BY WORCESTER COUNTY DEPARTMENT OF PUBLIC WORKS.

[Signature] 11/12/25
WORCESTER COUNTY, DIRECTOR OF PUBLIC WORKS DATE

DESCRIPTION	EXISTING	PROPOSED
ELECTRIC JUNCTION BOX		
ELECTRIC METER		
ELECTRIC TRANSFORMER		
ELECTRIC LIGHT POST		
ELECTRIC UTILITY MARKING		
ELECTRIC UGND LINE		
PROPERTY BOUNDARY		
PROPERTY MARKER		
SITE RIPRAP/GRAVEL		
SITE MONITORING/OBSERVATION WELL		
SITE SIGN		
SITE BOLLARD		
SITE UNKNOWN FEATURE		
SITE SPOT ELEVATION		
SITE CONCRETE		
SITE EDGE OF GRAVEL		
SITE DEMOLITION		
SITE PAVEMENT OVERLAY		
SITE PAVEMENT		
SITE FULL SECTION PAVEMENT RESTORATION		
SITE PERMANENT VEGETATIVE STABILIZATION		
SITE TRAFFIC BARRELS		
SITE SOIL BOUNDARY		
SITE SOIL CLASSIFICATION		
SITE STREAM CHANNEL		
SITE TREE/BRUSH LINE		
SITE LIMIT OF FIELD RUN SURVEY		

LEGEND

DESCRIPTION	EXISTING	PROPOSED
PLAN NORTH ARROW		
PLAN KEYNOTE CALLOUT		
PLAN REVISION CALLOUT		
PLAN SECTION CUT VIEW BEGIN		
PLAN SECTION CUT VIEW END		
ESC STABILIZED CONSTRUCTION ENTRANCE		
ESC SILT FENCE		
ESC SUPER SILT FENCE		
ESC CONCRETE WASHOUT STRUCTURE		

HORIZONTAL DATUM:
MD STATE PLANE, NAD 83,
US SURVEY FEET

VERTICAL DATUM:
NAVD 88

FULL SIZE PLOT: 24" x 36"

REVISIONS

NO.	DESCRIPTION

SEAL



PROFESSIONAL CERTIFICATION: I HEREBY CERTIFY THAT THESE DOCUMENTS WERE PREPARED OR APPROVED BY ME, AND THAT I AM A DULY LICENSED PROFESSIONAL ENGINEER UNDER THE LAWS OF THE STATE OF MARYLAND, LICENSE NO. 55422, EXPIRATION DATE: DECEMBER 16, 2025.

PROJECT NAME
BERLIN HOMEOWNER CONVENIENCE CENTER BULKHEAD REPAIR

PROJECT ADDRESS
**9696 MILL HAVEN ROAD
BERLIN, MD 21811**

DRAWING TITLE
TITLE SHEET

DRAWING INFORMATION

DRAWN BY: JWB DESIGNED BY: JWB/SCL
CHECKED BY: DOK PROJECT MANAGER: SCL

PROJECT NUMBER: 1060953

DRAWING NO.
G-001


DATE: NOVEMBER 2025 SHEET: 1 OF 11

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100% PLANS - FOR CONSTRUCTION



N/F
COUNTY COMMISSIONERS OF
WORCESTER COUNTY
DEED REF: 00692/00596, TAX MAP #25,
GRID #0012, PARCEL #0100

N/F
COUNTY COMMISSIONERS OF
WORCESTER COUNTY
DEED REF: 00704/00506, TAX MAP #25,
GRID #0011, PARCEL #0423

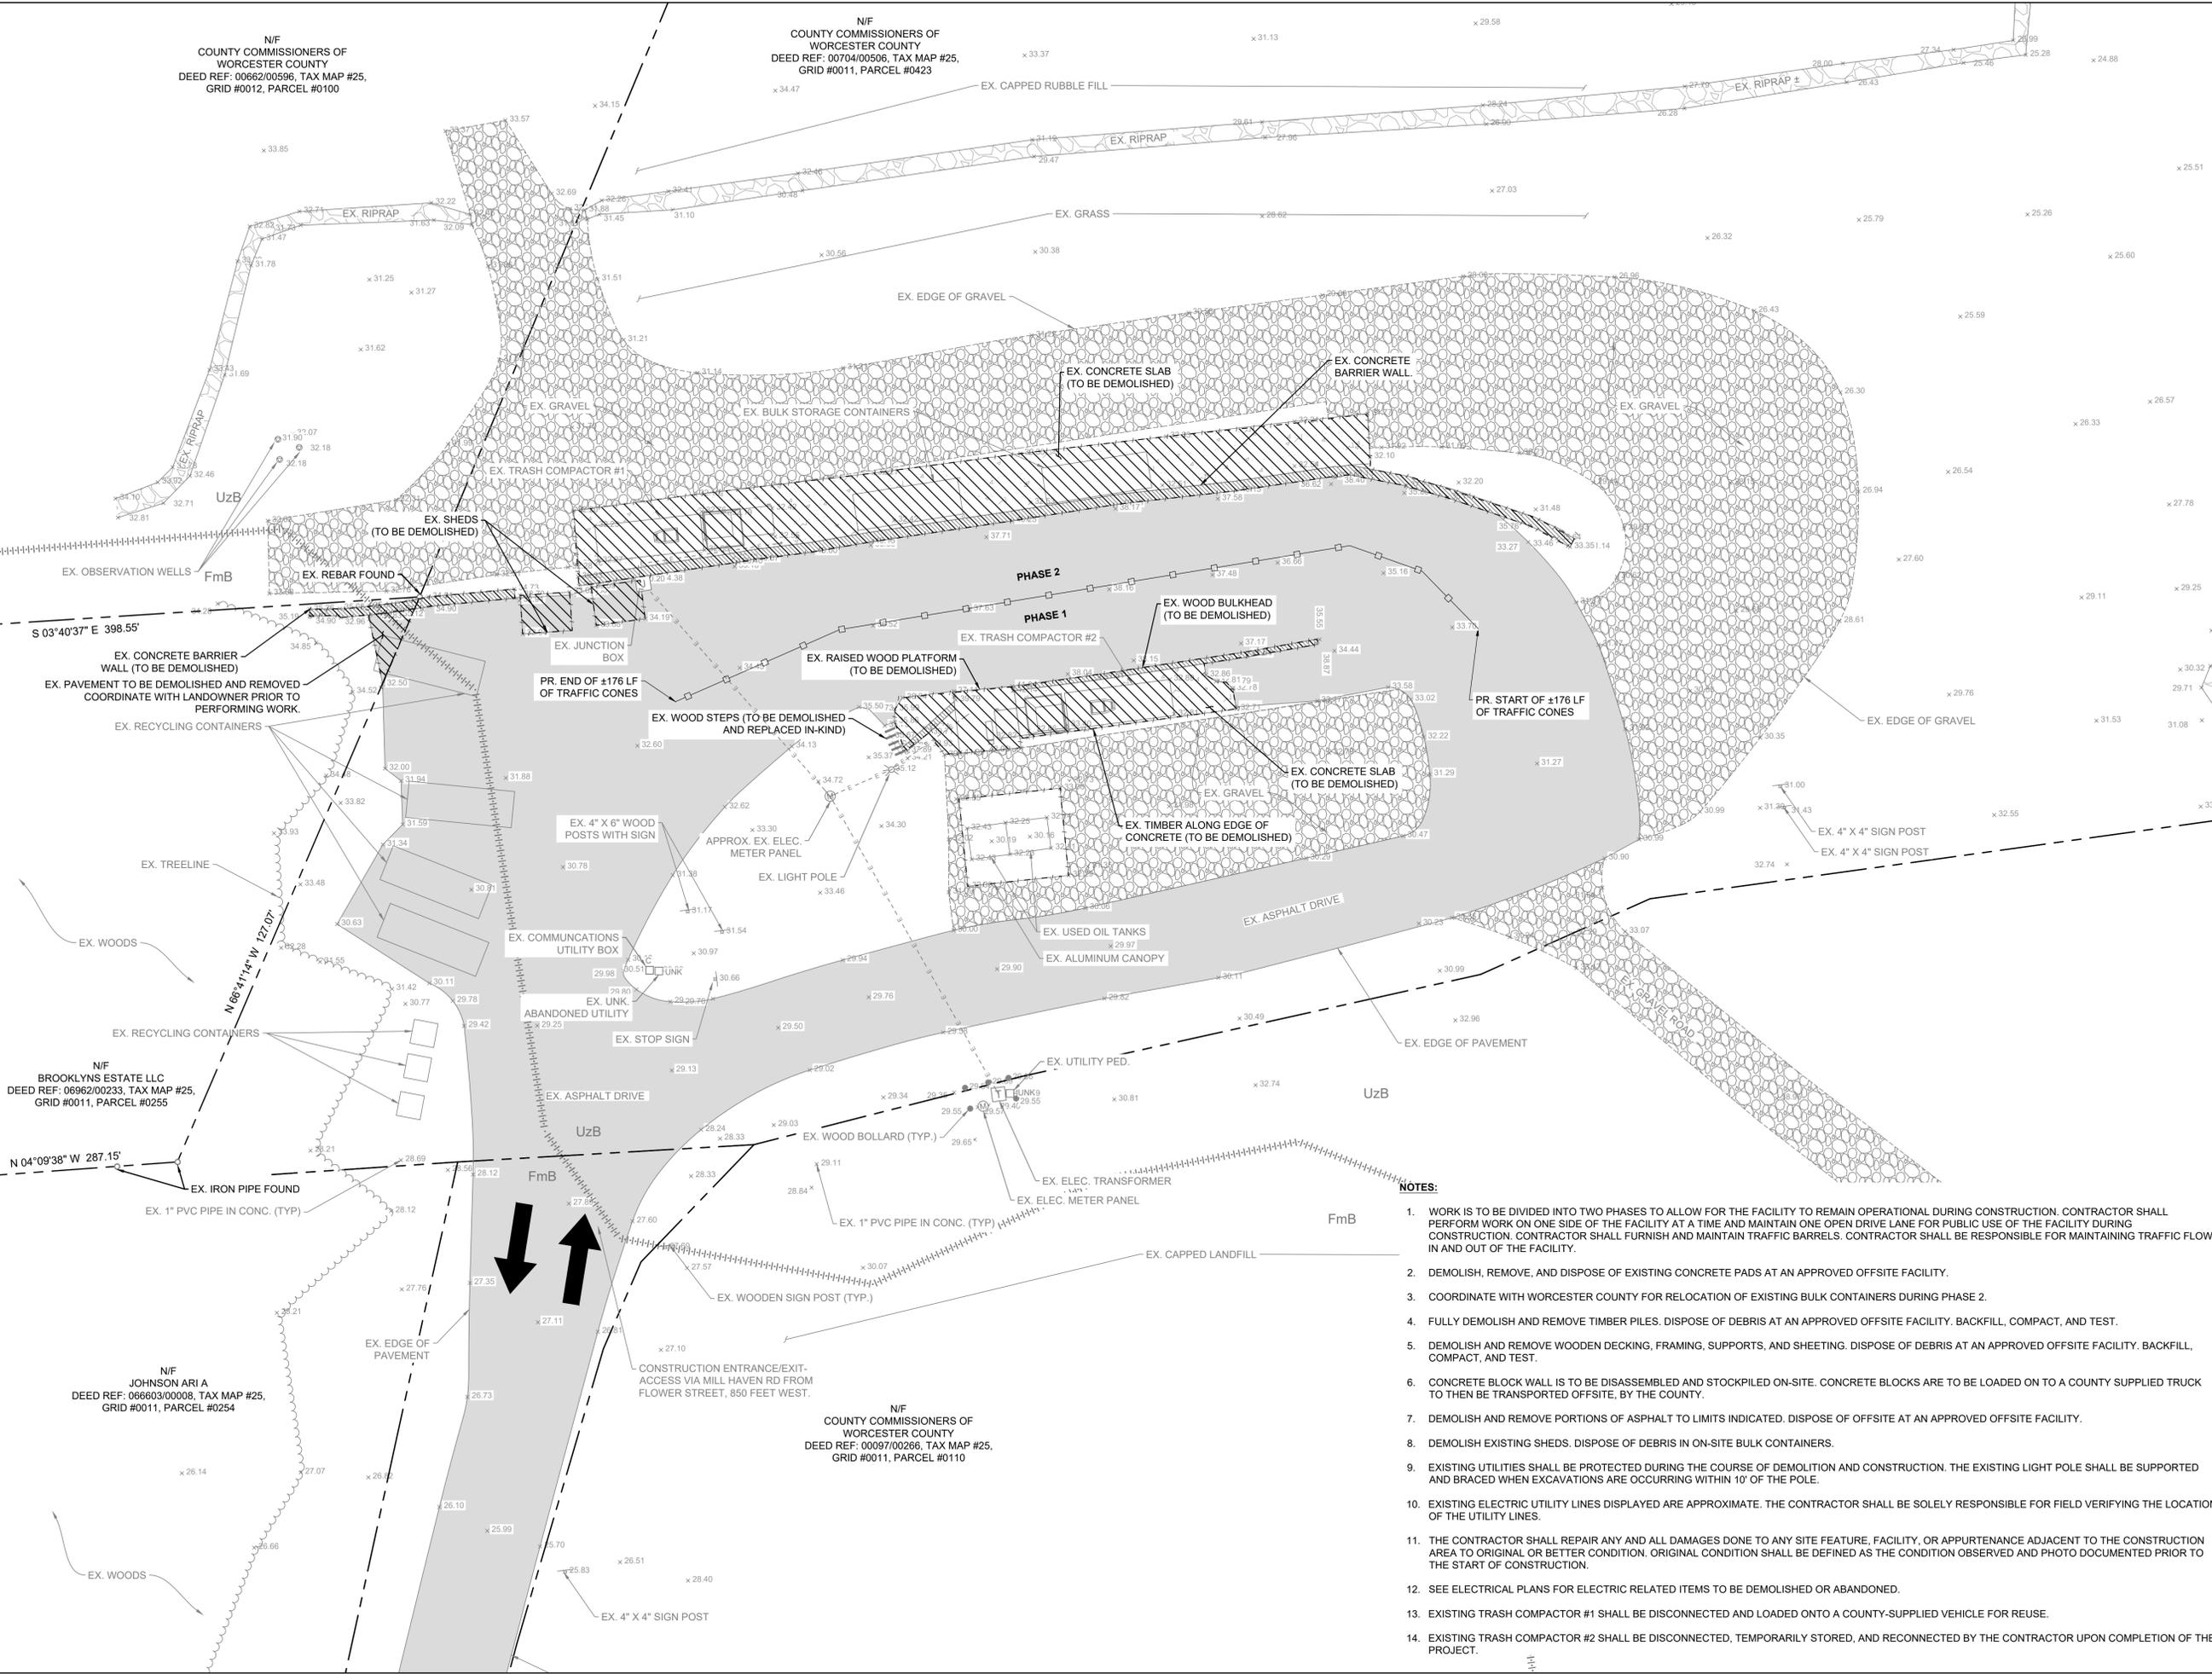

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NO.	REVISIONS

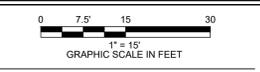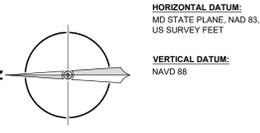

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PROJECT NAME
BERLIN HOMEOWNER
CONVENIENCE CENTER
BULKHEAD REPAIR

PROJECT ADDRESS
9696 MILL HAVEN ROAD
BERLIN, MD 21811

DRAWING TITLE
EXISTING CONDITIONS AND
DEMOLITION PLAN

DRAWING INFORMATION
DRAWN BY: JWB DESIGNED BY: JWB/SCL
CHECKED BY: DOK PROJECT MANAGER: SCL
PROJECT NUMBER: 1060953
DRAWING NO.
C-101
DATE: NOVEMBER 2025 SHEET: 2 OF 11

- NOTES:**
1. WORK IS TO BE DIVIDED INTO TWO PHASES TO ALLOW FOR THE FACILITY TO REMAIN OPERATIONAL DURING CONSTRUCTION. CONTRACTOR SHALL PERFORM WORK ON ONE SIDE OF THE FACILITY AT A TIME AND MAINTAIN ONE OPEN DRIVE LANE FOR PUBLIC USE OF THE FACILITY DURING CONSTRUCTION. CONTRACTOR SHALL FURNISH AND MAINTAIN TRAFFIC BARRELS. CONTRACTOR SHALL BE RESPONSIBLE FOR MAINTAINING TRAFFIC FLOW IN AND OUT OF THE FACILITY.
 2. DEMOLISH, REMOVE, AND DISPOSE OF EXISTING CONCRETE PADS AT AN APPROVED OFFSITE FACILITY.
 3. COORDINATE WITH WORCESTER COUNTY FOR RELOCATION OF EXISTING BULK CONTAINERS DURING PHASE 2.
 4. FULLY DEMOLISH AND REMOVE TIMBER PILES. DISPOSE OF DEBRIS AT AN APPROVED OFFSITE FACILITY. BACKFILL, COMPACT, AND TEST.
 5. DEMOLISH AND REMOVE WOODEN DECKING, FRAMING, SUPPORTS, AND SHEETING. DISPOSE OF DEBRIS AT AN APPROVED OFFSITE FACILITY. BACKFILL, COMPACT, AND TEST.
 6. CONCRETE BLOCK WALL IS TO BE DISASSEMBLED AND STOCKPILED ON-SITE. CONCRETE BLOCKS ARE TO BE LOADED ON TO A COUNTY SUPPLIED TRUCK TO THEN BE TRANSPORTED OFFSITE, BY THE COUNTY.
 7. DEMOLISH AND REMOVE PORTIONS OF ASPHALT TO LIMITS INDICATED. DISPOSE OF OFFSITE AT AN APPROVED OFFSITE FACILITY.
 8. DEMOLISH EXISTING SHEDS. DISPOSE OF DEBRIS IN ON-SITE BULK CONTAINERS.
 9. EXISTING UTILITIES SHALL BE PROTECTED DURING THE COURSE OF DEMOLITION AND CONSTRUCTION. THE EXISTING LIGHT POLE SHALL BE SUPPORTED AND BRACED WHEN EXCAVATIONS ARE OCCURRING WITHIN 10' OF THE POLE.
 10. EXISTING ELECTRIC UTILITY LINES DISPLAYED ARE APPROXIMATE. THE CONTRACTOR SHALL BE SOLELY RESPONSIBLE FOR FIELD VERIFYING THE LOCATION OF THE UTILITY LINES.
 11. THE CONTRACTOR SHALL REPAIR ANY AND ALL DAMAGES DONE TO ANY SITE FEATURE, FACILITY, OR APPURTENANCE ADJACENT TO THE CONSTRUCTION AREA TO ORIGINAL OR BETTER CONDITION. ORIGINAL CONDITION SHALL BE DEFINED AS THE CONDITION OBSERVED AND PHOTO DOCUMENTED PRIOR TO THE START OF CONSTRUCTION.
 12. SEE ELECTRICAL PLANS FOR ELECTRIC RELATED ITEMS TO BE DEMOLISHED OR ABANDONED.
 13. EXISTING TRASH COMPACTOR #1 SHALL BE DISCONNECTED AND LOADED ONTO A COUNTY-SUPPLIED VEHICLE FOR REUSE.
 14. EXISTING TRASH COMPACTOR #2 SHALL BE DISCONNECTED, TEMPORARILY STORED, AND RECONNECTED BY THE CONTRACTOR UPON COMPLETION OF THE PROJECT.

FILE PATH: \\C:\ADMIN\PROJECTS\WORCESTER COUNTY\1060953 - 01 - EX. EXISTING CONDITIONS AND DEMOLITION PLAN\DRAWINGS\STATION 11/2025 10:58 AM

100% PLANS - FOR CONSTRUCTION



EA Engineering, Science, and Technology, Inc., PBC

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Ocean Pines, Maryland 21811
(410) 641-5341

www.eaest.com

HORIZONTAL DATUM:
MD STATE PLANE, NAD 83,
US SURVEY FEET

VERTICAL DATUM:
NAVD 88



0 7.5' 15' 30'
1" = 15'
GRAPHIC SCALE IN FEET

FULL SIZE PLOT: 24" x 36"

REVISIONS

NO.	DESCRIPTION

SEAL



PROFESSIONAL CERTIFICATION: I HEREBY CERTIFY THAT THESE DOCUMENTS WERE PREPARED OR APPROVED BY ME, AND THAT I AM A DULY LICENSED PROFESSIONAL ENGINEER UNDER THE LAWS OF THE STATE OF MARYLAND. LICENSE NO. 55422 EXPIRATION DATE: DECEMBER 16, 2025


PROJECT NAME
BERLIN HOMEOWNER CONVENIENCE CENTER BULKHEAD REPAIR

PROJECT ADDRESS
**9696 MILL HAVEN ROAD
BERLIN, MD 21811**

DRAWING TITLE
PROPOSED SITE LAYOUT

DRAWING INFORMATION
DRAWN BY: JWB DESIGNED BY: JWB/SCL
CHECKED BY: DOK PROJECT MANAGER: SCL
PROJECT NUMBER: 1060953

DRAWING NO.
C-102
DATE: NOVEMBER 2025 SHEET: 3 OF 11

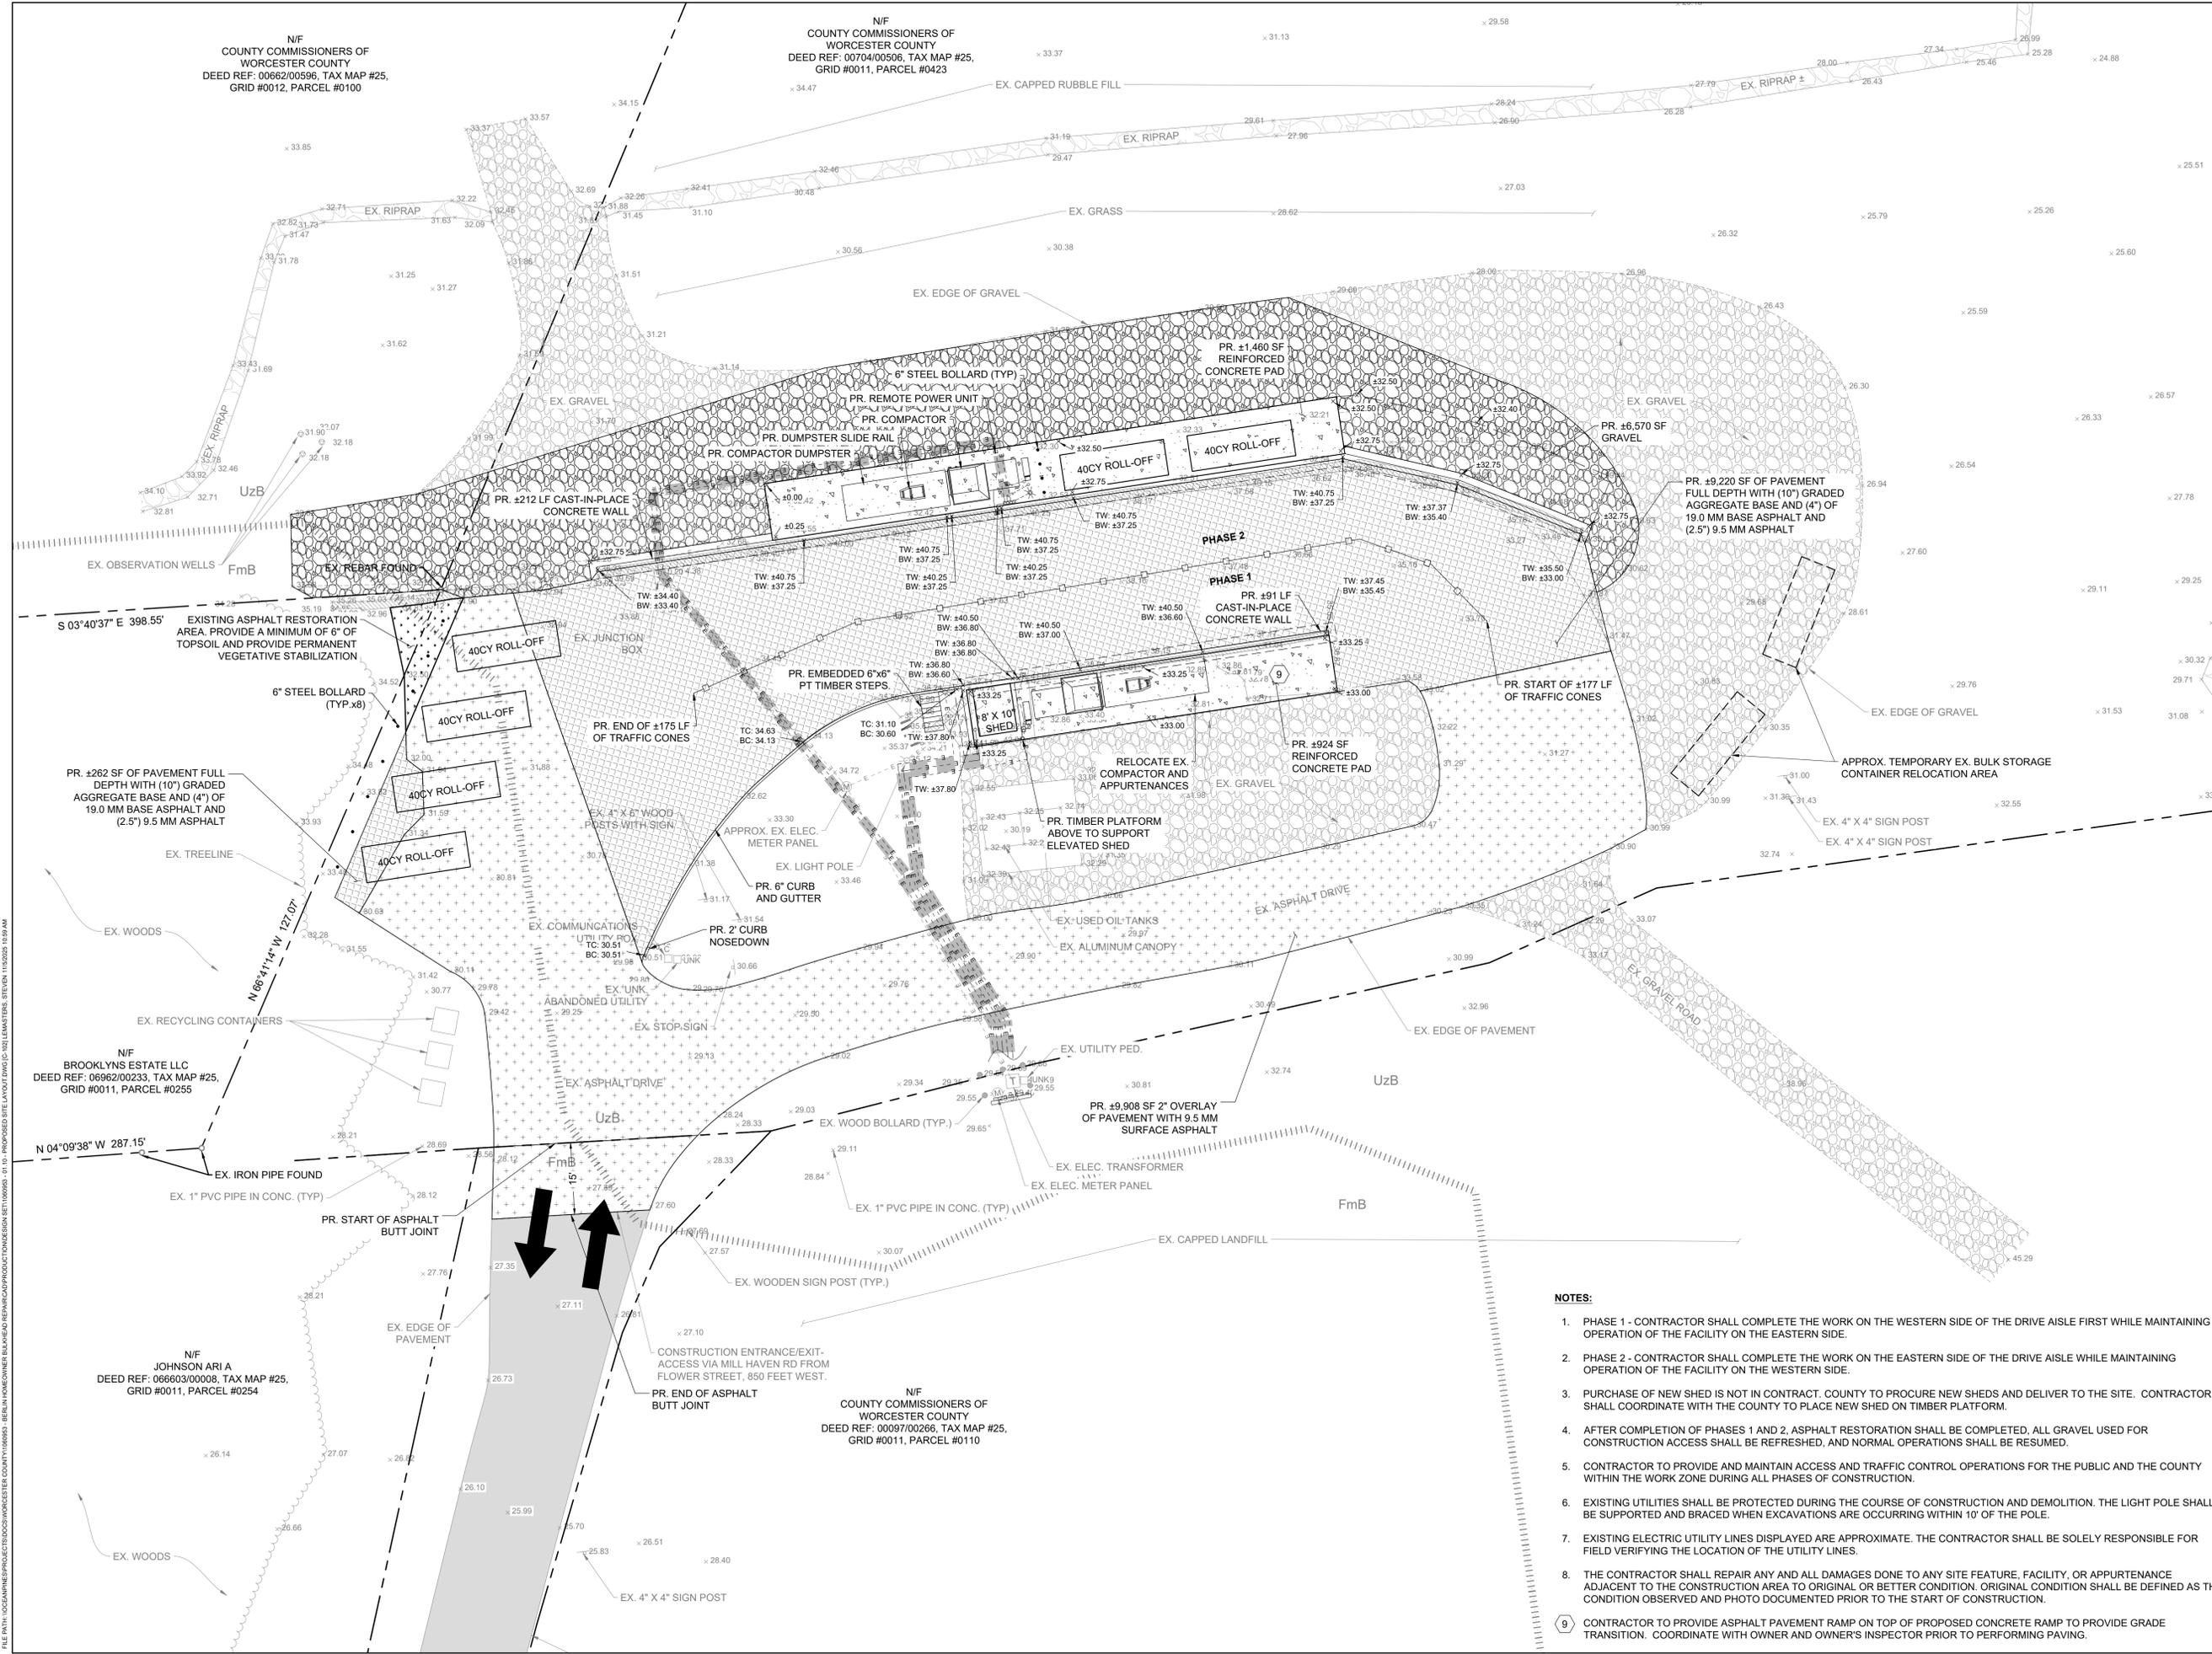

NOTES:

- PHASE 1 - CONTRACTOR SHALL COMPLETE THE WORK ON THE WESTERN SIDE OF THE DRIVE AISLE FIRST WHILE MAINTAINING OPERATION OF THE FACILITY ON THE EASTERN SIDE.
- PHASE 2 - CONTRACTOR SHALL COMPLETE THE WORK ON THE EASTERN SIDE OF THE DRIVE AISLE WHILE MAINTAINING OPERATION OF THE FACILITY ON THE WESTERN SIDE.
- PURCHASE OF NEW SHED IS NOT IN CONTRACT. COUNTY TO PURCHASE NEW SHEDS AND DELIVER TO THE SITE. CONTRACTOR SHALL COORDINATE WITH THE COUNTY TO PLACE NEW SHED ON TIMBER PLATFORM.
- AFTER COMPLETION OF PHASES 1 AND 2, ASPHALT RESTORATION SHALL BE COMPLETED. ALL GRAVEL USED FOR CONSTRUCTION ACCESS SHALL BE REFRESHED, AND NORMAL OPERATIONS SHALL BE RESUMED.
- CONTRACTOR TO PROVIDE AND MAINTAIN ACCESS AND TRAFFIC CONTROL OPERATIONS FOR THE PUBLIC AND THE COUNTY WITHIN THE WORK ZONE DURING ALL PHASES OF CONSTRUCTION.
- EXISTING UTILITIES SHALL BE PROTECTED DURING THE COURSE OF CONSTRUCTION AND DEMOLITION. THE LIGHT POLE SHALL BE SUPPORTED AND BRACED WHEN EXCAVATIONS ARE OCCURRING WITHIN 10' OF THE POLE.
- EXISTING ELECTRIC UTILITY LINES DISPLAYED ARE APPROXIMATE. THE CONTRACTOR SHALL BE SOLELY RESPONSIBLE FOR FIELD VERIFYING THE LOCATION OF THE UTILITY LINES.
- THE CONTRACTOR SHALL REPAIR ANY AND ALL DAMAGES DONE TO ANY SITE FEATURE, FACILITY, OR APPURTENANCE ADJACENT TO THE CONSTRUCTION AREA TO ORIGINAL OR BETTER CONDITION. ORIGINAL CONDITION SHALL BE DEFINED AS THE CONDITION OBSERVED AND PHOTO DOCUMENTED PRIOR TO THE START OF CONSTRUCTION.
- CONTRACTOR TO PROVIDE ASPHALT PAVEMENT RAMP ON TOP OF PROPOSED CONCRETE RAMP TO PROVIDE GRADE TRANSITION. COORDINATE WITH OWNER AND OWNER'S INSPECTOR PRIOR TO PERFORMING PAVING.

FILE PATH: \\C:\ADMIN\PROJECTS\BERLIN\CONVENIENCE CENTER\BULKHEAD REPAIR\DWG\C-102.DWG DATE: 11/16/2025 10:59 AM

100% PLANS - FOR CONSTRUCTION

N/F
COUNTY COMMISSIONERS OF
WORCESTER COUNTY
DEED REF: 00692/00596, TAX MAP #25,
GRID #0012, PARCEL #0100

N/F
COUNTY COMMISSIONERS OF
WORCESTER COUNTY
DEED REF: 00704/00506, TAX MAP #25,
GRID #0011, PARCEL #0423

**SOIL CLASSIFICATION
TABLE**


SOIL TYPE	% OF SITE AREA
FmB	11
UzB	89



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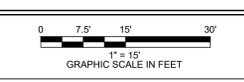
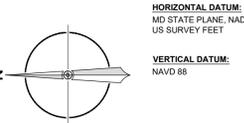
11200 Racetrack Road, Unit A101
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(410) 641-5341

www.eaest.com

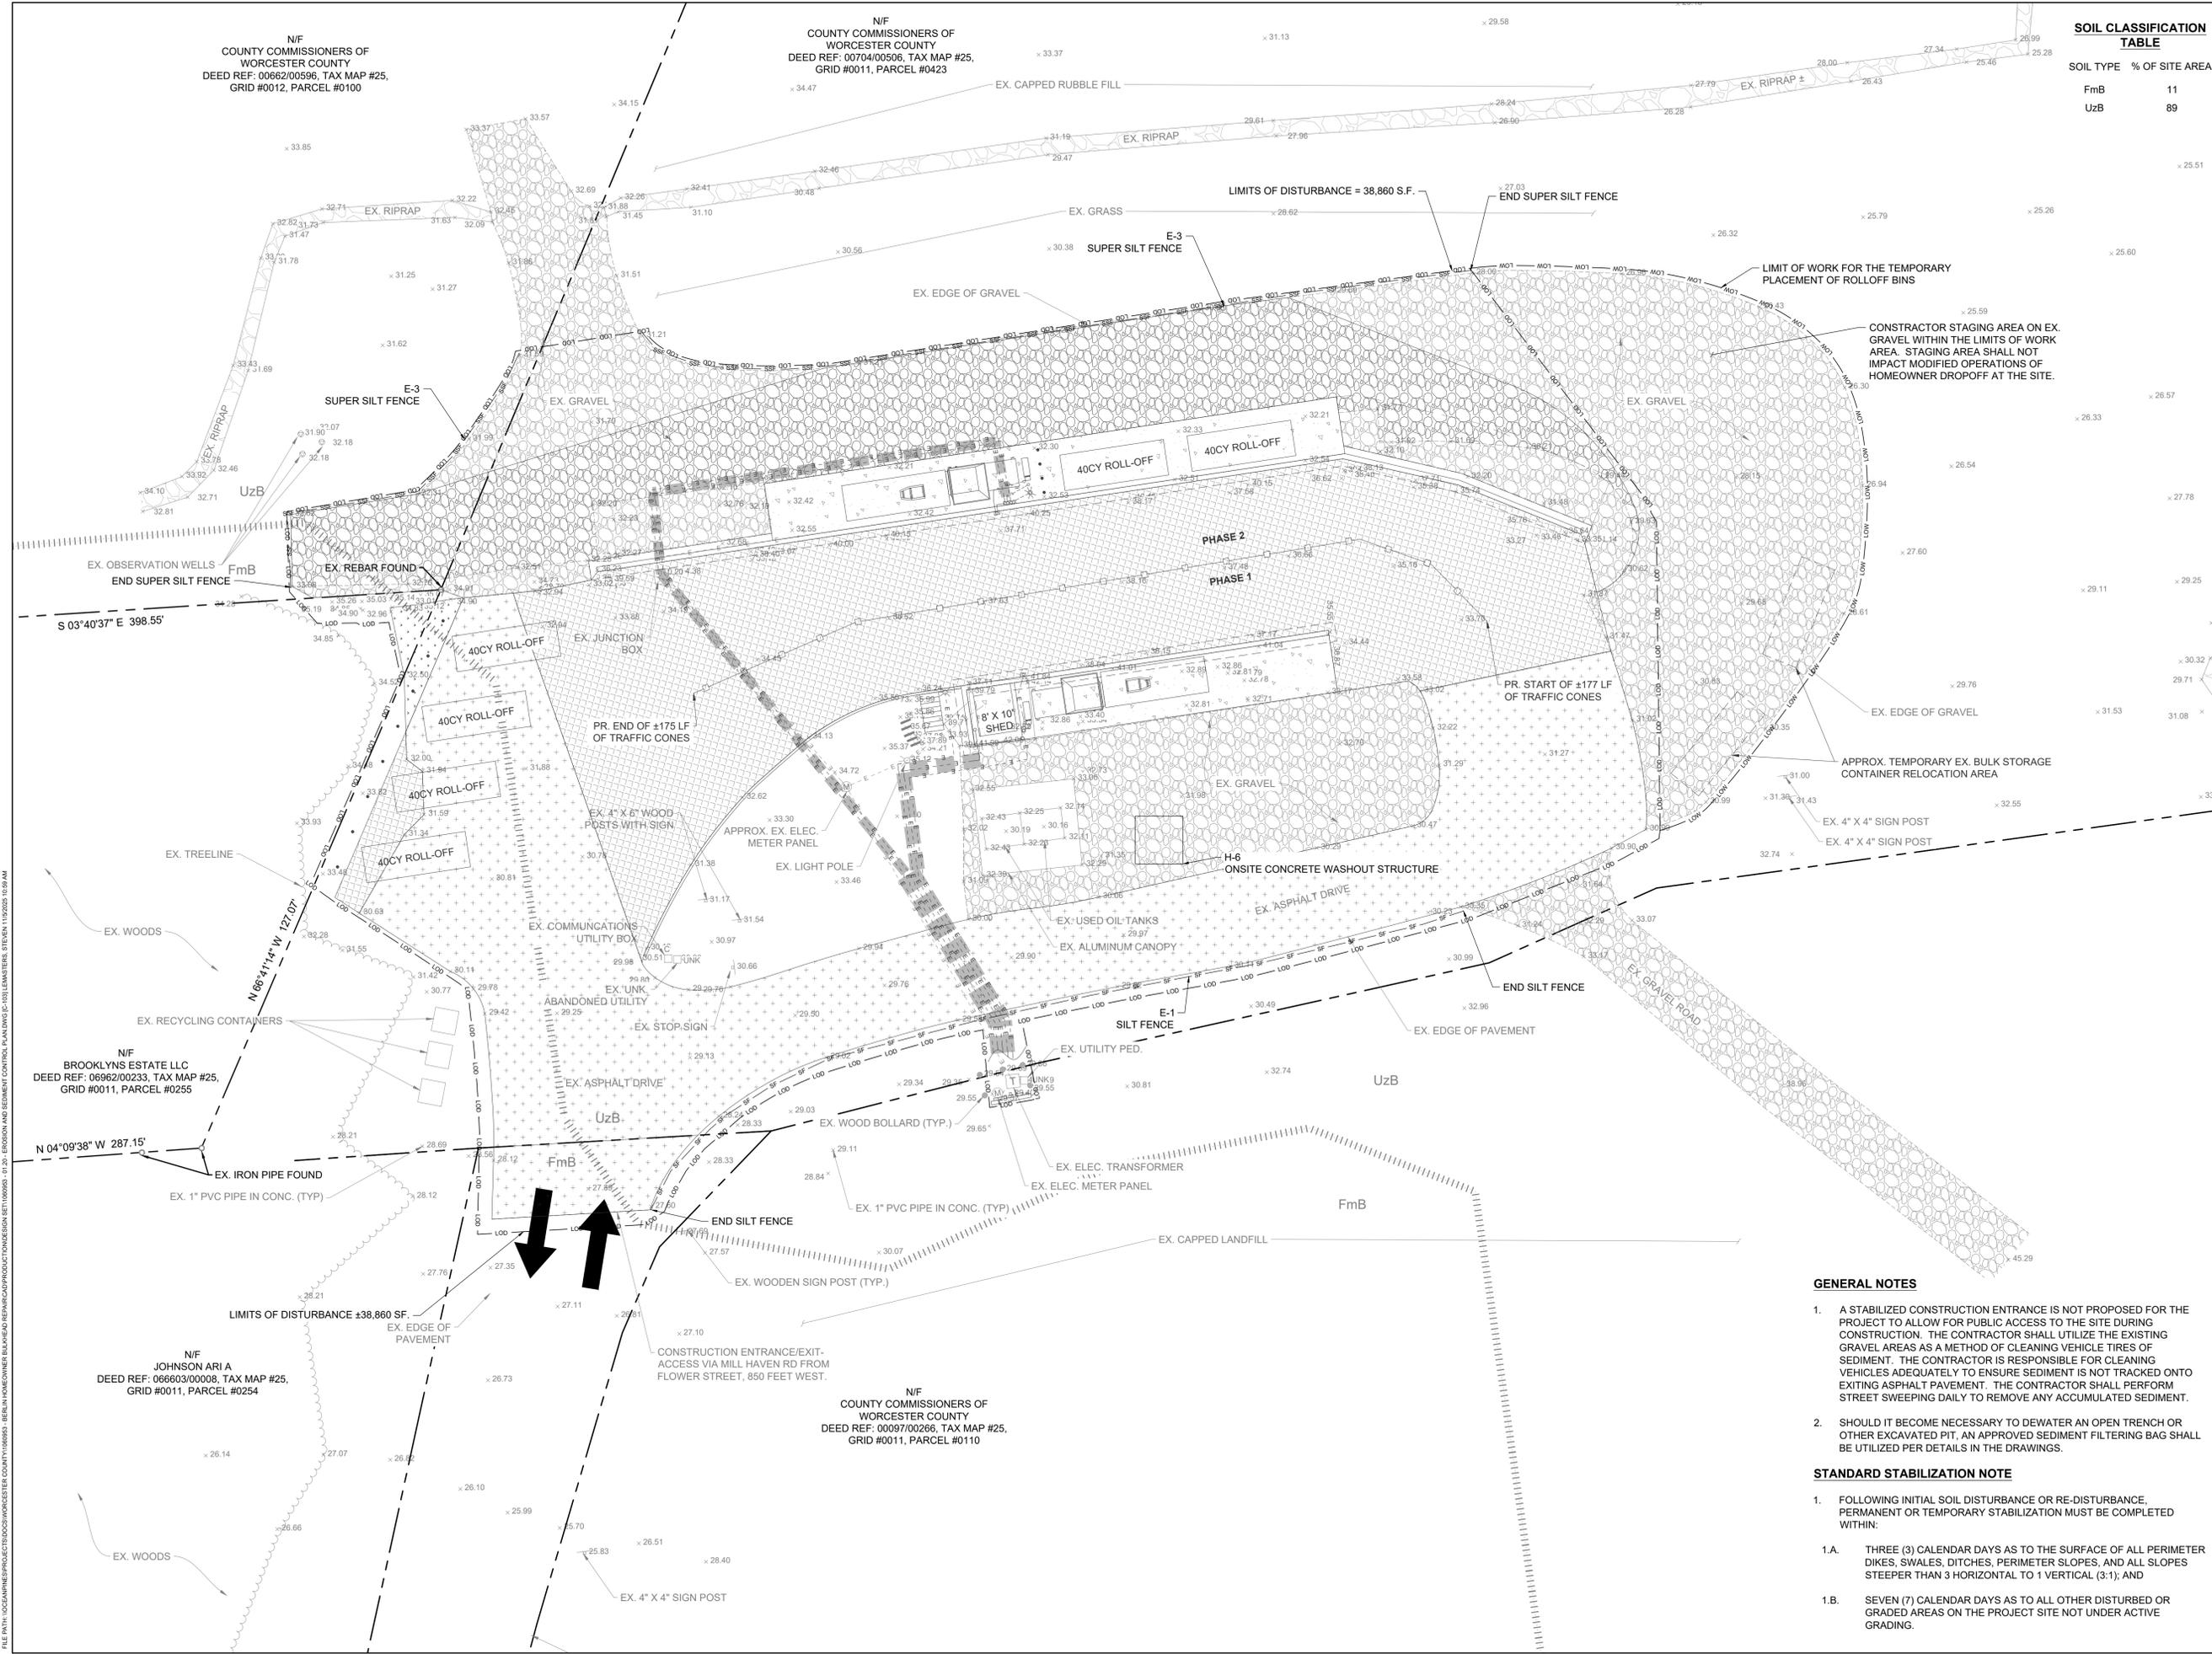

CONTRACTOR STAGING AREA ON EX. GRAVEL WITHIN THE LIMITS OF WORK AREA. STAGING AREA SHALL NOT IMPACT MODIFIED OPERATIONS OF HOMEOWNER DROPOFF AT THE SITE.

APPROX. TEMPORARY EX. BULK STORAGE CONTAINER RELOCATION AREA



FULL SIZE PLOT: 24" x 36"

REVISIONS

NO.	DESCRIPTION



PROFESSIONAL CERTIFICATION: I HEREBY CERTIFY THAT THESE DOCUMENTS WERE PREPARED OR APPROVED BY ME, AND THAT I AM A DULY LICENSED PROFESSIONAL ENGINEER UNDER THE LAWS OF THE STATE OF MARYLAND.
LICENSE NO. 55422
EXPIRATION DATE: DECEMBER 16, 2025

PROJECT NAME
BERLIN HOMEOWNER
CONVENIENCE CENTER
BULKHEAD REPAIR

PROJECT ADDRESS
9696 MILL HAVEN ROAD
BERLIN, MD 21811

DRAWING TITLE
EROSION AND SEDIMENT
CONTROL PLAN

DRAWING INFORMATION
DRAWN BY: JWB DESIGNED BY: JWB/SCL
CHECKED BY: DOK PROJECT MANAGER: SCL
PROJECT NUMBER: 1060953
DRAWING NO.
C-103
DATE: NOVEMBER 2025 SHEET: 4 OF 11

- GENERAL NOTES**
- A STABILIZED CONSTRUCTION ENTRANCE IS NOT PROPOSED FOR THE PROJECT TO ALLOW FOR PUBLIC ACCESS TO THE SITE DURING CONSTRUCTION. THE CONTRACTOR SHALL UTILIZE THE EXISTING GRAVEL AREAS AS A METHOD OF CLEANING VEHICLE TIRES OF SEDIMENT. THE CONTRACTOR IS RESPONSIBLE FOR CLEANING VEHICLES ADEQUATELY TO ENSURE SEDIMENT IS NOT TRACKED ONTO EXITING ASPHALT PAVEMENT. THE CONTRACTOR SHALL PERFORM STREET SWEEPING DAILY TO REMOVE ANY ACCUMULATED SEDIMENT.
 - SHOULD IT BECOME NECESSARY TO DEWATER AN OPEN TRENCH OR OTHER EXCAVATED PIT, AN APPROVED SEDIMENT FILTERING BAG SHALL BE UTILIZED PER DETAILS IN THE DRAWINGS.

- STANDARD STABILIZATION NOTE**
- FOLLOWING INITIAL SOIL DISTURBANCE OR RE-DISTURBANCE, PERMANENT OR TEMPORARY STABILIZATION MUST BE COMPLETED WITHIN:
 - THREE (3) CALENDAR DAYS AS TO THE SURFACE OF ALL PERIMETER DIKES, SWALES, DITCHES, PERIMETER SLOPES, AND ALL SLOPES STEEPER THAN 3 HORIZONTAL TO 1 VERTICAL (3:1); AND
 - SEVEN (7) CALENDAR DAYS AS TO ALL OTHER DISTURBED OR GRADED AREAS ON THE PROJECT SITE NOT UNDER ACTIVE GRADING.

FILE PATH: \\C:\ADMIN\PROJECTS\WORCESTER COUNTY\1060953 - 01-20 - EROSION AND SEDIMENT CONTROL PLAN\DWG\C-103.EMASTER.DWG (REVISED 11/20/25 10:09 AM)

100% PLANS - FOR CONSTRUCTION

B-4 STANDARDS AND SPECIFICATIONS FOR VEGETATIVE STABILIZATION

DEFINITION
USING VEGETATION AS COVER TO PROTECT EXPOSED SOIL FROM EROSION.

PURPOSE
TO PROMOTE THE ESTABLISHMENT OF VEGETATION ON EXPOSED SOIL.

CONDITIONS WHERE PRACTICE APPLIES
ON ALL DISTURBED AREAS NOT STABILIZED BY OTHER METHODS. THIS SPECIFICATION IS DIVIDED INTO SECTIONS ON INCREMENTAL STABILIZATION, SOIL PREPARATION, SOIL AMENDMENTS AND TOPSOILING, SEEDING AND MULCHING, TEMPORARY STABILIZATION, AND PERMANENT STABILIZATION.

EFFECTS ON WATER QUALITY AND QUANTITY
STABILIZATION PRACTICES ARE USED TO PROMOTE THE ESTABLISHMENT OF VEGETATION ON EXPOSED SOIL. WHEN SOIL IS STABILIZED WITH VEGETATION, THE SOIL IS LESS LIKELY TO ERODE AND MORE LIKELY TO ALLOW INFILTRATION OF RAINFALL, THEREBY REDUCING SEDIMENT LOADS AND RUNOFF TO DOWNSTREAM AREAS.

PLANTING VEGETATION IN DISTURBED AREAS WILL HAVE AN EFFECT ON THE WATER BUDGET, ESPECIALLY ON VOLUMES AND RATES OF RUNOFF, INFILTRATION, EVAPORATION, TRANSPIRATION, PERCOLATION, AND GROUNDWATER RECHARGE. OVER TIME, VEGETATION WILL INCREASE ORGANIC MATTER CONTENT AND IMPROVE THE WATER HOLDING CAPACITY OF THE SOIL AND SUBSEQUENT PLANT GROWTH.

VEGETATION WILL HELP REDUCE THE MOVEMENT OF SEDIMENT, NUTRIENTS, AND OTHER CHEMICAL CARRIED BY RUNOFF TO RECEIVING WATERS. PLANTS WILL ALSO HELP PROTECT GROUNDWATER SUPPLIES BY ASSIMILATING THOSE SUBSTANCES PRESENT WITHIN THE ROOT ZONE.

SEDIMENT CONTROL PRACTICES MUST REMAIN IN PLACE DURING GRADING, SEEDED PREPARATION, SEEDING, MULCHING, AND VEGETATIVE ESTABLISHMENT.

ADEQUATE VEGETATIVE ESTABLISHMENT
INSPECT SEEDED AREAS FOR VEGETATIVE ESTABLISHMENT AND MAKE NECESSARY REPAIRS, REPLACEMENTS, AND RESEEDINGS WITHIN THE PLANTING SEASON.

1. ADEQUATE VEGETATIVE STABILIZATION REQUIRES 95 PERCENT GROUND COVER.
2. IF AN AREA HAS LESS THAN 40 PERCENT GROUND COVER, REESTABLISH FOLLOWING THE ORIGINAL RECOMMENDATIONS FOR LIME, FERTILIZER, SEEDED PREPARATION, AND SEEDING.
3. IF AN AREA HAS BETWEEN 40 AND 94 PERCENT GROUND COVER, OVER-SEED AND FERTILIZE USING HALF OF THE RATES ORIGINALLY SPECIFIED.
4. MAINTENANCE FERTILIZER RATES FOR PERMANENT SEEDING ARE SHOWN IN TABLE B.6.

B-4-1 STANDARDS AND SPECIFICATIONS FOR INCREMENTAL STABILIZATION

DEFINITION
ESTABLISHMENT OF VEGETATIVE COVER ON CUT AND FILL SLOPES.

PURPOSE
TO PROVIDE TIMELY VEGETATIVE COVER ON CUT AND FILL SLOPES AS WORK PROGRESSES.

CONDITIONS WHERE PRACTICE APPLIES
ANY CUT OR FILL SLOPE GREATER THAN 15 FEET IN HEIGHT. THIS PRACTICE ALSO APPLIES TO STOCKPILES.

CRITERIA

1. INCREMENTAL STABILIZATION - CUT SLOPES
EXCAVATE AND STABILIZE CUT SLOPES IN INCREMENTS NOT TO EXCEED 15 FEET IN HEIGHT. PREPARE SEEDED AND APPLY SEED AND MULCH ON ALL CUT SLOPES AS THE WORK PROGRESSES.
2. CONSTRUCTION SEQUENCE EXAMPLE (REFER TO FIGURE B.1):
2.a. CONSTRUCT AND STABILIZE ALL TEMPORARY SWALE DIKES THAT WILL BE USED TO CONVEY RUNOFF AROUND THE EXCAVATION.
2.b. PERFORM PHASE 1 EXCAVATION, PREPARE SEEDED, AND STABILIZE.
2.c. PERFORM PHASE 2 EXCAVATION, PREPARE SEEDED, AND STABILIZE.
2.d. PERFORM PHASE 3 EXCAVATION, PREPARE SEEDED, AND STABILIZE. OVERSEED PREVIOUSLY SEEDED AREAS AS NECESSARY.

NOTE: ONCE EXCAVATION HAS BEGUN, THE OPERATION SHOULD BE CONTINUOUS FROM GRUBBING THROUGH THE COMPLETION OF GRADING AND PLACEMENT OF TOPSOIL (IF REQUIRED) AND PERMANENT SEED AND MULCH. ANY INTERRUPTIONS IN THE OPERATION OR COMPLETING THE OPERATION OUT OF THE SEEDING SEASON WILL NECESSITATE THE APPLICATION OF TEMPORARY STABILIZATION.

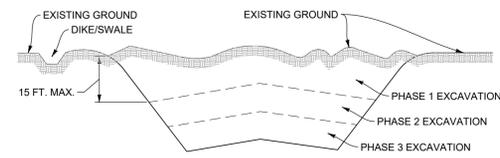


FIGURE B.1: INCREMENTAL STABILIZATION - CUT

1. INCREMENTAL STABILIZATION - FILL SLOPES
CONSTRUCT AND STABILIZE FILL SLOPES IN INCREMENTS NOT TO EXCEED 15 FEET IN HEIGHT. PREPARE SEEDED AND APPLY SEED AND MULCH ON ALL SLOPES AS THE WORK PROGRESSES.

2. STABILIZE SLOPES IMMEDIATELY WHEN THE VERTICAL HEIGHT OF A LIFT REACHES 15 FEET OR WHEN THE GRADING OPERATION CEASES AS PRESCRIBED IN THE PLANS.
3. AT THE END OF EACH DAY, INSTALL TEMPORARY WATER CONVEYANCE PRACTICE(S), AS NECESSARY, TO INTERCEPT SURFACE RUNOFF AND CONVEY IT DOWN THE SLOPE IN A NON-EROSIVE MANNER.
4. CONSTRUCTION SEQUENCE EXAMPLE (REFER TO FIGURE B.2):
4.a. CONSTRUCT AND STABILIZE ALL TEMPORARY SWALES OR DIKES THAT WILL BE USED TO DIVERT RUNOFF AROUND THE FILL. CONSTRUCT SILT FENCE ON LOW SIDE OF FILL UNLESS OTHER METHODS SHOWN ON THE PLANS ADDRESS THIS AREA.
4.b. AT THE END OF THE DAY, INSTALL TEMPORARY WATER CONVEYANCE PRACTICE(S), AS NECESSARY, TO INTERCEPT SURFACE RUNOFF AND CONVEY IT DOWN THE SLOPE IN A NON-EROSIVE MANNER.
4.c. PLACE PHASE 1 FILL, PREPARE SEEDED, AND STABILIZE.
4.d. PLACE PHASE 2 FILL, PREPARE SEEDED, AND STABILIZE.
4.e. PLACE FINAL PHASE FILL, PREPARE SEEDED, AND STABILIZE. OVERSEED PREVIOUSLY SEEDED AREAS AS NECESSARY.

NOTE: ONCE THE PLACEMENT OF FILL HAS BEGUN, THE OPERATION SHOULD BE CONTINUOUS FROM GRUBBING THROUGH THE COMPLETION OF GRADING AND PLACEMENT OF TOPSOIL (IF REQUIRED) AND PERMANENT SEED AND MULCH. ANY INTERRUPTIONS IN THE OPERATION OR COMPLETING THE OPERATION OUT OF THE SEEDING SEASON WILL NECESSITATE THE APPLICATION OF TEMPORARY STABILIZATION.

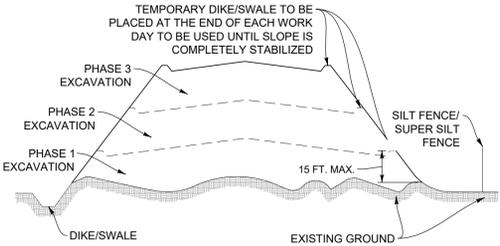


FIGURE B.2: INCREMENTAL STABILIZATION - FILL

B-4-2 STANDARDS AND SPECIFICATIONS FOR SOIL PREPARATION, TOPSOILING, AND SOIL AMENDMENTS

DEFINITION
THE PROCESS OF PREPARING THE SOILS TO SUSTAIN ADEQUATE VEGETATIVE STABILIZATION.

PURPOSE
TO PROVIDE A SUITABLE SOIL MEDIUM FOR VEGETATIVE GROWTH.

CONDITIONS WHERE PRACTICE APPLIES
WHERE VEGETATIVE STABILIZATION IS TO BE ESTABLISHED.

A. SOIL PREPARATION

1. TEMPORARY STABILIZATION
1.a. SEED PREPARATION CONSISTS OF LOOSENING SOIL TO A DEPTH OF 3 TO 5 INCHES BY MEANS OF SUITABLE AGRICULTURAL OR CONSTRUCTION EQUIPMENT, SUCH AS DISC HARROWS OR CHISEL PLOW OR RIPPERS EQUIPPED ON CONSTRUCTION EQUIPMENT. AFTER SOIL IS LOOSENEED, IT MUST NOT BE ROLLED OR DRAGGED SMOOTH BUT LEFT IN ROUGHENED CONDITION. SLOPES 3:1 OR FLATTER ARE TO BE TRACKED WITH RIDGES RUNNING PARALLEL TO THE CONTOUR OF THE SLOPE.
1.b. APPLY FERTILIZER AND LIME AS PRESCRIBED ON THE PLANS.
1.c. INCORPORATE LIME AND FERTILIZER INTO THE TOP 3 TO 5 INCHES OF SOIL BY DISKING OR OTHER SUITABLE MEANS
2. PERMANENT STABILIZATION
2.a. A SOIL TEST IS REQUIRED FOR ANY EARTH DISTURBANCE OF 5 ACRES OR MORE. THE MINIMUM SOIL CONDITIONS REQUIRED FOR PERMANENT VEGETATIVE ESTABLISHMENT ARE:
a. SOIL PH BETWEEN 6.0 TO 7.0.
b. SOLUBLE SALTS LESS THAN 500 PARTS PER MILLION (PPM).
c. SOIL CONTAINS LESS THAN 40 PERCENT CLAY BUT ENOUGH FINE GRAINED MATERIAL (GREATER THAN 30 PERCENT FINE PLUS CLAY) TO PROVIDE THE CAPACITY TO HOLD A MODERATE AMOUNT OF MOISTURE. AN EXCEPTION: IF LOVEGRASS WILL BE PLANTED, THEN A SANDY SOIL (LESS THAN 30 PERCENT SILT PLUS CLAY) WOULD BE ACCEPTABLE.
d. SOIL CONTAINS 1.5 PERCENT MINIMUM ORGANIC MATTER BY WEIGHT.
e. SOIL CONTAINS SUFFICIENT PORE SPACE TO PERMIT ADEQUATE ROOT PENETRATION.
2.b. APPLICATION OF AMENDMENTS OR TOPSOIL IS REQUIRED IF ON-SITE SOILS DO NOT MEET THE ABOVE CONDITIONS.
2.c. GRADED AREAS MUST BE MAINTAINED IN A TRUE AND EVEN GRADE AS SPECIFIED ON THE APPROVED PLAN, THEN SCARIFIED OR OTHERWISE LOOSENEED TO A DEPTH OF 3 TO 5 INCHES.
2.d. APPLY SOIL AMENDMENTS AS SPECIFIED ON THE APPROVED PLAN OR AS INDICATED BY THE RESULTS OF SOIL TESTS.
2.e. MIX SOIL AMENDMENTS INTO THE TOP 3 TO 5 INCHES OF SOIL BY DISKING OR OTHER SUITABLE MEANS. RAKE LAWN AREAS TO SMOOTH THE SURFACE. REMOVE LARGE OBJECTS LIKE STONES AND BRANCHES, AND READY THE AREA FOR SEED APPLICATION BY HYDROSEEDING. DO NOT DRAGGING WITH A HEAVY CHAIN OR OTHER EQUIPMENT TO ROUGHEN THE SURFACE WHERE SITE CONDITIONS WILL NOT PERMIT NORMAL SEEDED PREPARATION. TRACK SLOPES 3:1 OR FLATTER WITH TRACKED EQUIPMENT LEAVING THE SOIL IN AN IRREGULAR CONDITION WITH RIDGES RUNNING PARALLEL TO THE CONTOUR OF THE SLOPE. LEAVE THE TOP 1 TO 3 INCHES OF SOIL LOOSE AND FRIBLE. SEEDED LOOSENING MAY BE UNNECESSARY ON NEWLY DISTURBED AREAS.

B. TOPSOILING

1. TOPSOIL IS PLACED OVER PREPARED SUBSOIL PRIOR TO ESTABLISHMENT OF PERMANENT VEGETATION. THE PURPOSE IS TO PROVIDE A SUITABLE SOIL MEDIUM FOR VEGETATIVE GROWTH. SOILS OF CONCERN HAVE LOW MOISTURE CONTENT, LOW NUTRIENT LEVELS, OR CONTAIN MATERIALS TOXIC TO PLANTS, AND/OR UNACCEPTABLE SOIL GRADATION.
1.b. TOPSOIL SALVAGED FROM AN EXISTING SITE MAY BE USED PROVIDED IT MEETS THE STANDARDS AS SET FORTH IN THESE SPECIFICATIONS. TYPICALLY, THE DEPTH OF TOPSOIL TO BE SALVAGED FROM AN EXISTING SITE IS 1 TO 3 INCHES IN REPRESENTATIVE SOIL PROFILE SECTION IN THE SOIL SURVEY PUBLISHED BY USDA-NRCS.
2. TOPSOILING IS LIMITED TO AREAS HAVING 2:1 OR FLATTER SLOPES WHERE:
2.a. THE TEXTURE OF THE EXPOSED SUBSOIL MATERIAL IS NOT ADEQUATE TO PRODUCE VEGETATIVE GROWTH.
2.b. THE SOIL MATERIAL IS SO SHALLOW THAT THE ROOTING ZONE IS NOT DEEP ENOUGH TO SUPPORT PLANTS OR FURNISH CONTINUING SUPPLIES OF MOISTURE AND PLANT MATERIAL.
2.c. THE ORIGINAL SOIL TO BE VEGETATED CONTAINS MATERIAL TOXIC TO PLANT GROWTH.
2.d. THE SOIL IS SO ACIDIC THAT TREATMENT WITH LIMESTONE IS NOT FEASIBLE.
2.e. AREAS HAVING SLOPES STEEPER THAN 2:1 REQUIRE SPECIAL CONSIDERATION AND DESIGN.
3. TOPSOIL SPECIFICATIONS: SOIL TO BE USED AS TOPSOIL MUST MEET THE FOLLOWING CRITERIA:
3.a. TOPSOIL MUST BE A LOAM, SANDY LOAM, CLAY LOAM, SILT LOAM, SANDY CLAY LOAM, OR LOAMY SAND. OTHER SOILS MAY BE USED IF SOIL TESTS RECOMMENDED BY AN AGRONOMIST OR SOIL SCIENTIST AND APPROVED BY THE APPROPRIATE APPROVAL AUTHORITY. TOPSOIL MUST NOT BE A MIXTURE OF CONTRASTING TEXTURED SUBSOILS AND MUST CONTAIN LESS THAN 5 PERCENT BY VOLUME OF CINDERS, STONES, SLAG, COARSE FRAGMENTS, GRAVEL, STICKS, ROOTS, TRASH, OR OTHER MATERIALS LARGER THAN 1 1/2 INCHES IN DIAMETER.
3.b. TOPSOIL MUST BE FREE OF NOXIOUS PLANTS OR PLANT PARTS SUCH AS BERMUDA GRASS, QUACK GRASS, JOHNSON GRASS, NUT SEDGE, POISON TAYL, THISTLE, OR OTHERS AS SPECIFIED.
3.c. TOPSOIL SUBSTITUTES OR AMENDMENTS, AS RECOMMENDED BY A QUALIFIED AGRONOMIST OR SOIL SCIENTIST AND APPROVED BY THE APPROPRIATE APPROVAL AUTHORITY, MAY BE USED IN LIEU OF NATURAL TOPSOIL.
4. TOPSOIL APPLICATION
4.a. EROSION AND SEDIMENT CONTROL PRACTICES MUST BE MAINTAINED WHEN APPLYING TOPSOIL.
4.b. UNIFORMLY DISTRIBUTE TOPSOIL IN A 5 TO 8 INCH LAYER AND LIGHTLY COMPACT TO A MINIMUM THICKNESS OF 4 INCHES. SPREADING IS TO BE PERFORMED IN SUCH A MANNER THAT SODDING OR SEEDING CAN PROCEED WITH A MINIMUM OF ADDITIONAL SOIL PREPARATION AND TILLAGE. ANY IRREGULARITIES IN THE SPREADING FROM TOPSOILING OR OTHER OPERATIONS MUST BE CORRECTED IN ORDER TO PREVENT THE FORMATION OF DEPRESSIONS OR WATER POCKETS.
4.c. TOPSOIL MUST NOT BE PLACED IF THE TOPSOIL OR SUBSOIL IS IN A FROZEN OR MUDDY CONDITION, WHEN THE SUBSOIL IS EXCESSIVELY WET OR IN A CONDITION THAT MAY OTHERWISE BE DETRIMENTAL TO PROPER GRADING AND SEEDED PREPARATION.

C. SOIL AMENDMENTS (FERTILIZER AND LIME SPECIFICATIONS)

1. SOIL TESTS MUST BE SUBMITTED TO DETERMINE THE EXACT RATIOS AND APPLICATION RATES FOR BOTH LIME AND FERTILIZER ON SITES HAVING DISTURBED AREAS OF 5 ACRES OR MORE. SOIL ANALYSIS MAY BE PERFORMED BY A RECOGNIZED PRIVATE OR COMMERCIAL LABORATORY. SOIL SAMPLES TAKEN FOR ENGINEERING PURPOSES MAY ALSO BE USED FOR CHEMICAL ANALYSES.
2. FERTILIZERS MUST BE UNIFORM IN COMPOSITION, FREE FLOWING AND SUITABLE FOR ACCURATE APPLICATION BY APPROPRIATE EQUIPMENT. MANURE MAY BE SUBSTITUTED FOR FERTILIZER WITH PRIOR APPROVAL FROM THE APPROPRIATE APPROVAL AUTHORITY. FERTILIZERS MUST ALL BE DELIVERED TO THE SITE FULLY LABELED ACCORDING TO THE APPLICABLE LAWS AND MUST BEAR THE NAME, TRADE NAME OR TRADEMARK AND WARRANTY OF THE PRODUCER.
3. LIME MATERIALS MUST BE GROUND LIMESTONE OR LIME. LIME MATERIALS MAY BE SUBSTITUTED EXCEPT WHEN HYDROSEEDING WHICH CONTAINS AT LEAST 50 PERCENT TOTAL OXIDES (CALCIUM OXIDE PLUS MAGNESIUM OXIDE). LIMESTONE MUST BE GROUND TO SUCH FINENESS THAT AT LEAST 50 PERCENT WILL PASS THROUGH A #100 MESH SIEVE AND 98 TO 100 PERCENT WILL PASS THROUGH A #20 MESH SIEVE.
4. LIME AND FERTILIZER ARE TO BE EVENLY DISTRIBUTED AND INCORPORATED INTO THE TOP 3 TO 5 INCHES OF SOIL BY DISKING OR OTHER SUITABLE MEANS.
5. WHERE THE SUBSOIL IS EITHER HIGHLY ACIDIC OR COMPOSED OF HEAVY CLAYS, SPREAD GROUND LIMESTONE AT THE RATE OF 4 TO 8 TONS/ACRE (200-400 POUNDS PER 1,000 SQUARE FEET) PRIOR TO THE PLACEMENT OF TOPSOIL.

B-4-3 STANDARDS AND SPECIFICATIONS FOR SEEDING AND MULCHING

DEFINITION
THE APPLICATION OF SEED AND MULCH TO ESTABLISH VEGETATIVE COVER.

PURPOSE
TO PROTECT DISTURBED SOILS FROM EROSION DURING AND AT THE END OF CONSTRUCTION.

CONDITIONS WHERE PRACTICE APPLIES
TO THE SURFACE OF ALL PERIMETER CONTROLS, SLOPES, AND ANY DISTURBED AREA NOT UNDER ACTIVE GRADING.

A. SEEDING

1. SPECIFICATIONS
1.a. ALL SEED MUST MEET THE REQUIREMENT OF THE MARYLAND STATE SEED LAW. ALL SEED MUST BE SUBJECT TO RE-TESTING BY A RECOGNIZED SEED LABORATORY. ALL SEED MUST HAVE BEEN TESTED WITHIN THE 6 MONTHS IMMEDIATELY PRECEDING THE DATE OF SOWING SUCH MATERIAL ON ANY PROJECT. REFER TO TABLE B.4 REGARDING THE QUALITY OF SEED. SEED TAGS MUST BE AVAILABLE UPON REQUEST TO THE INSPECTOR TO VERIFY TYPE OF SEED AND SEEDING RATE.
1.b. MULCH ALONE MAY BE APPLIED BETWEEN THE FALL AND SPRING SEEDING DATES ONLY IF THE GROUND IS FROZEN. THE APPROPRIATE SEEDING MIXTURE MUST BE APPLIED WHEN THE GROUND THAWS.
1.c. INOCULANTS: THE INOCULANT FOR TREATING LEGUME SEED IN THE SEED MIXTURES MUST BE A PURE CULTURE OF NITROGEN FIXING BACTERIA PREPARED SPECIFICALLY FOR THE SPECIES. INOCULANTS MUST NOT BE USED LATER THAN THE DATE INDICATED ON THE CONTAINER. ADD FRESH INOCULANTS AS DIRECTED ON THE PACKAGE. USE FOUR TIMES THE RECOMMENDED RATE OF SEEDING. NOTE: IT IS VERY IMPORTANT TO KEEP INOCULANT AS COOL AS POSSIBLE UNTIL USED. TEMPERATURES ABOVE 75 TO 80 DEGREES FAHRENHEIT CAN WEAKEN BACTERIA AND MAKE THE INOCULANT LESS EFFECTIVE.
1.d. SOD AND SEED MUST NOT BE PLACED ON SOIL WHICH HAS BEEN TREATED WITH SOIL STERILANTS OR CHEMICALS USED FOR WEED CONTROL UNTIL SUFFICIENT TIME HAS ELAPSED (14 DAYS MIN) TO PERMIT DISSIPATION OF PHYTO-TOXIC MATERIALS.
2. APPLICATION
2.a. DRY SEEDING: THIS INCLUDES USE OF CONVENTIONAL DROP OR BROADCAST SEEDERS.
2.a. INCORPORATE SEED INTO THE SUBSOIL AT THE RATES PRESCRIBED ON TEMPORARY SEEDING TABLE B.1. FOR PERMANENT SEEDING TABLE B.3, OR SITE-SPECIFIC SEEDING SUMMARIES.
2.b. APPLY SEED IN TWO DIRECTIONS, PERPENDICULAR TO EACH OTHER. APPLY HALF THE SEEDING RATE IN EACH DIRECTION. ROLL THE SEEDED AREA WITH A WEIGHTED ROLLER TO PROVIDE GOOD SEED TO SOIL CONTACT.
2.B. DRILL OR CULTIPACKER SEEDING: MECHANIZED SEEDERS THAT APPLY AND COVER SEED WITH SOIL.
a. CULTIPACKER SEEDERS ARE REQUIRED TO BURY THE SEED IN SUCH A FASHION AS TO PROVIDE AT LEAST 1/2 INCH OF SOIL COVERING. SEEDED MUST BE FIRM AFTER PLANTING.
b. APPLY SEED IN TWO DIRECTIONS, PERPENDICULAR TO EACH OTHER. APPLY HALF THE SEEDING RATE IN EACH DIRECTION.
2.C. HYDROSEEDING: APPLY SEED UNIFORMLY WITH HYDROSEEDER (SLURRY INCLUDES SEED AND FERTILIZER).
a. IF FERTILIZER IS BEING APPLIED AT THE TIME OF SEEDING, THE APPLICATION RATES SHOULD BE EXCEED THE FOLLOWING: NITROGEN: 100 POUNDS PER ACRE TOTAL SOLUBLE NITROGEN; P₂O₅ (PHOSPHOROUS): 200 POUNDS PER ACRE; K₂O (POTASSIUM): 200 POUNDS PER ACRE.
b. LIME: USE ONLY GROUND AGRICULTURAL LIMESTONE (UP TO 3 TONS PER ACRE) MAY BE APPLIED BY HYDROSEEDING. NORMALLY, NOT MORE THAN 2 TONS ARE APPLIED BY HYDROSEEDING AT ANY ONE TIME. DO NOT USE BURNT OR HYDRATED LIME WHEN HYDROSEEDING.
c. MIX SEED AND FERTILIZER ON SITE AND SEED IMMEDIATELY AND WITHOUT INTERRUPTION.
d. WHEN HYDROSEEDING, DO NOT INCORPORATE INTO THE SOIL.

B. MULCHING

1. MULCH MATERIALS (IN ORDER OF PREFERENCE)
1.a. STRAW CONSISTING OF HIGHLY THRESHED WHEAT, RYE, OAT, OR BARLEY AND REASONABLE BRIGHT IN COLOR. STRAW IS TO BE FREE OF NOXIOUS WOOD SEEDS AS SPECIFIED IN THE MARYLAND SEED LAW AND NOT MUSTY, MOLDY, CAKED, DECAYED, OR EXCESSIVELY DUSTY. NOTE: USE ONLY RIGID STRAW MULCH IN AREAS WHERE ONE SPECIES OF GRASS IS DESIRED.
1.b. WOOD CELLULOSE FIBER MULCH (WCFM) CONSISTING OF SPECIALLY PREPARED WOOD CELLULOSE PROCESSED INTO A UNIFORM FIBROUS PHYSICAL STATE.
a. WCFM IS TO BE DYED GREEN OR CONTAIN A GREEN DYE IN THE PACKAGE THAT WILL PROVIDE AN APPROPRIATE COLOR TO FACILITATE VISUAL INSPECTION OF THE UNIFORMLY SPREAD SLURRY.
b. WCFM, INCLUDING DYE, MUST CONTAIN NO GERMINATION OR GROWTH INHIBITING FACTORS.
c. WCFM MATERIALS ARE TO BE MANUFACTURED AND PROCESSED IN SUCH A MANNER THAT THE WOOD CELLULOSE FIBER MULCH WILL REMAIN IN UNIFORM SUSPENSION IN WATER UNDER AGITATION AND WILL BLEND WITH SEED, FERTILIZER AND OTHER ADDITIVES TO FORM A HOMOGENOUS SLURRY. THE MULCH MATERIAL MUST FORM A BLOTTER-LIKE GROUND COVER, ON APPLICATION, HAVING MOISTURE ABSORPTION AND PERCOLATION PROPERTIES AND MUST COVER AND AND DESIGN.
d. WCFM MATERIAL MUST NOT CONTAIN ELEMENTS OR COMPOUNDS AT CONCENTRATION LEVELS THAT WILL BE PHYTO-TOXIC.
e. WCFM MUST CONFORM TO THE FOLLOWING PHYSICAL REQUIREMENTS: FIBER LENGTH OF APPROXIMATELY 10 MILLIMETERS, DIAMETER APPROXIMATELY 1 MILLIMETER, PH RANGE OF 4.0 TO 8.5, ASH CONTENT OF 1.6 PERCENT MAXIMUM AND WATER HOLDING CAPACITY OF 90 PERCENT MINIMUM.
2. APPLICATION
2.a. APPLY MULCH TO ALL SEEDED AREAS IMMEDIATELY AFTER SEEDING.
2.b. WHEN STRAW MULCH IS USED, SPREAD IT OVER ALL SEEDED AREAS AT THE RATE OF 2 TONS PER ACRE TO A UNIFORM LOOSE DEPTH OF 1 TO 2 INCHES. APPLY MULCH TO ACHIEVE A UNIFORM DISTRIBUTION AND DEPTH SO THAT THE SOIL SURFACE IS NOT EXPOSED. WHEN USING A MULCH ANCHORING TOOL, INCREASE THE APPLICATION RATE TO 2.5 TONS PER ACRE.
2.c. WOOD CELLULOSE FIBER USED AS MULCH MUST BE APPLIED AT A NET DRY WEIGHT OF 100 POUNDS PER ACRE. MIX THE WOOD CELLULOSE FIBER WITH WATER TO ATTAIN A MIXTURE WITH A MAXIMUM OF 50 POUNDS OF WOOD CELLULOSE FIBER PER 100 GALLONS OF WATER.
3. ANCHORING
3.a. PERFORM MULCH ANCHORING IMMEDIATELY FOLLOWING APPLICATION OF MULCH TO MINIMIZE LOSS BY WIND OR WATER. THIS MAY BE DONE BY ONE OF THE FOLLOWING METHODS (LISTED BY PREFERENCE), DEPENDING UPON THE SIZE OF THE AREA AND EROSION HAZARD:
a. A MULCH ANCHORING TOOL IS A TRACTOR DRAWN IMPLEMENT DESIGNED TO PUNCH AND ANCHOR MULCH INTO THE SOIL SURFACE A MINIMUM OF 2 INCHES. THIS PRACTICE IS MOST EFFECTIVE ON LARGE AREAS, BUT IS LIMITED TO FLATTER SLOPES WHERE EQUIPMENT CAN OPERATE SAFELY. IF USED ON SLOPING LAND, THIS PRACTICE SHOULD FOLLOW THE CONTOUR.
b. WOOD CELLULOSE FIBER MAY BE USED FOR ANCHORING STRAW. APPLY THE FIBER BINDER AT A NET DRY WEIGHT OF 750 POUNDS PER ACRE. MIX THE WOOD CELLULOSE FIBER WITH WATER AT A MAXIMUM OF 50 POUNDS OF WOOD CELLULOSE FIBER PER 100 GALLONS OF WATER.
c. SYNTHETIC BINDERS SUCH AS ACRYLIC DLR (AGRO-TACK), DCA-70, PETROSEAL, TERRA TAC II, TERRA TACK OR OTHER APPROVED EQUAL MAY BE USED. FOLLOW APPLICATION RATES AS SPECIFIED BY THE MANUFACTURER. APPLICATION OF LIQUID BINDERS WILL NOT BE ACCEPTABLE IF HEAVIER AT THE EDGES WHERE WIND CATCHES MULCH, SUCH AS IN VALLEYS AND ON CRESTS OF BANKS. USE OF ASPHALT BINDERS IS STRICTLY PROHIBITED.
d. LIGHTWEIGHT PLASTIC NETTING MAY BE STAPLED OVER THE MULCH ACCORDING TO MANUFACTURER RECOMMENDATIONS. NETTING IS USUALLY AVAILABLE IN ROLLS 4 TO 15 FEET WIDE AND 300 TO 3,000 FEET LONG.

B-4-4 STANDARDS AND SPECIFICATIONS FOR TEMPORARY STABILIZATION

DEFINITION
TO STABILIZE DISTURBED SOILS WITH VEGETATION FOR UP TO 6 MONTHS.

PURPOSE
TO USE FAST GROWING VEGETATION THAT PROVIDES COVER ON DISTURBED SOILS.

CONDITIONS WHERE PRACTICE APPLIES
EXPOSED SOILS WHERE GROUND COVER IS NEEDED FOR A PERIOD OF 6 MONTHS OR LESS. FOR LONGER DURATION OF TIME, PERMANENT STABILIZATION PRACTICES ARE REQUIRED.

- A. SELECT ONE OR MORE OF THE SPECIES OR SEED MIXTURES LISTED IN TABLE B.1 FOR THE APPROPRIATE PLANT HARDNESS ZONE (FROM FIGURE B.3), AND ENTER THEM IN THE TEMPORARY SEEDING SUMMARY. SEEDING DATES, SEEDING RATES, SEEDING DEPTHS, AND SEEDING DEPTHS, IF THE SUMMARY IS NOT PUT ON THE PLAN AND COMPLETED, THEN TABLE B.1 PLUS FERTILIZER AND LIME RATES MUST BE PUT ON THE PLAN.
- B. FOR SITES HAVING SOIL TESTS PERFORMED, USE AND SHOW THE RECOMMENDED RATES BY THE TESTING AGENCY. SOIL TESTS ARE NOT REQUIRED FOR TEMPORARY SEEDING.

C. WHEN STABILIZATION IS REQUIRED OUTSIDE OF A SEEDING SEASON, APPLY SEED AND MULCH OR STRAW MULCH ALONG AS PRESCRIBED IN SECTION B-4-3 A.1, B AND MAINTAIN UNTIL THE NEXT SEEDING SEASON.

TEMPORARY SEEDING SUMMARY

NO.	SPECIES	APPLICATION RATE(LB/AC)	SEEDING DATES	SEEDING DEPTHS	FERTILIZER RATE (10-20-20)		LIME RATE
					N	P ₂ O ₅	
HARDNESS ZONE: 7b							
SEED MIXTURE:							
	ANNUAL RYEGRASS	40	FEB. 15-APR. 30 AUG. 15-NOV. 30	0.5 inches			
	FOXTAIL MILLET	30	MAY 1-NOV. 14	0.5 inches	436 LB/AC (10 LB/ 1000SF)	2 TONS/AC (90 LB/ 1000SF)	

B-4-5 STANDARDS AND SPECIFICATIONS FOR PERMANENT STABILIZATION

DEFINITION
TO STABILIZE DISTURBED SOILS WITH PERMANENT VEGETATION.

PURPOSE
TO USE LONG-LIVED PERENNIAL GRASSES AND LEGUMES TO ESTABLISH PERMANENT COVER ON DISTURBED SOILS.

CONDITIONS WHERE PRACTICE APPLIES
EXPOSED SOILS WHERE GROUND COVER IS NEEDED FOR 6 MONTHS OR MORE.

CRITERIA

- A. SEED MIXTURES
1. GENERAL USE
1.a. SELECT ONE OR MORE OF THE SPECIES OR MIXTURES LISTED IN TABLE B.3 FOR THE APPROPRIATE PLANT HARDNESS ZONE (FROM FIGURE B.3) AND BASED ON THE SITE CONDITION OR PURPOSE FOUND ON TABLE B.2. ENTER SELECTED MIXTURE(S), APPLICATION RATES, AND SEEDING DATES IN THE PERMANENT SEEDING SUMMARY. THE SUMMARY IS TO BE PLACED ON THE PLAN.
1.b. ADDITIONAL PLANTING SPECIFICATIONS FOR EXCEPTIONAL SITES SUCH AS SHORELINES, STREAM BANKS, OR DUNES OR FOR SPECIAL PURPOSES SUCH AS WILDLIFE OR AESTHETIC TREATMENT MAY BE FOUND IN USDA-NRCS TECHNICAL FIELD OFFICE GUIDE, SECTION 342 - CRITICAL AREA PLANTING.
1.c. FOR SITES HAVING DISTURBED AREA OVER 5 ACRES, USE AND SHOW THE RATES RECOMMENDED BY THE SOIL TESTING AGENCY.
1.d. FOR AREAS RECEIVING LOW MAINTENANCE, APPLY UREA FORM FERTILIZER (46-0-0) AT 31 POUNDS PER 1000 SQUARE FEET (150 POUNDS PER ACRE) AT THE TIME OF SEEDING IN ADDITION TO THE SOIL AMENDMENTS SHOWN IN THE PERMANENT SEEDING SUMMARY.
2. TURFGRASS MIXTURES
2.a. AREAS WITH TURFGRASS MAY BE DESIRED INCLUDE LAWNS, PARKS, PLAYGROUNDS, AND COMMERCIAL SITES WHICH WILL RECEIVE A MEDIUM TO HIGH LEVEL OF MAINTENANCE.
2.b. SELECT ONE OR MORE OF THE SPECIES OR MIXTURES LISTED BELOW BASED ON THE SITE CONDITIONS OR PURPOSE. ENTER SELECTED MIXTURE(S), APPLICATION RATES, AND SEEDING DATES IN THE PERMANENT SEEDING SUMMARY. THE SUMMARY IS TO BE PLACED ON THE PLAN:
a. KENTUCKY BLUEGRASS: FULL SUN MIXTURE: FOR USE IN AREAS THAT RECEIVE INTENSIVE MANAGEMENT. IRRIGATION REQUIRED IN THE AREAS OF CENTRAL MARYLAND AND EASTERN SHORE. RECOMMENDED CERTIFIED KENTUCKY BLUEGRASS CULTIVARS SEEDING RATE: 1.5 TO 2.0 POUNDS PER 1000 SQUARE FEET. CHOOSE A MINIMUM OF THREE KENTUCKY BLUEGRASS CULTIVARS WITH EACH RANGING FROM 10 TO 35 POUNDS PER 1000 SQUARE FEET.
b. KENTUCKY BLUEGRASS/PERENNIAL RYE: FULL SUN MIXTURE: FOR USE IN FULL SUN AREAS WHERE RAPID ESTABLISHMENT IS NECESSARY AND WHEN TURF WILL RECEIVE MEDIUM TO INTENSIVE MANAGEMENT.
c. TALL FESCUE/KENTUCKY BLUEGRASS: FULL SUN MIXTURE: FOR USE IN DROUGHT PRONE AREAS AND/OR FOR AREAS RECEIVING LOW TO MEDIUM MANAGEMENT IN FULL SUN TO MEDIUM SHADE. RECOMMENDED MIXTURE INCLUDES: CERTIFIED TALL FESCUE CULTIVARS 95 TO 100 PERCENT, CERTIFIED KENTUCKY BLUEGRASS CULTIVARS 10 TO 5 PERCENT. SEEDING RATE: 5 TO 8 POUNDS PER 1000 SQUARE FEET. ONE OR MORE CULTIVARS MAY BE BLENDED.
d. KENTUCKY BLUEGRASS/FINE FESCUE: SHADE MIXTURE: FOR USE IN AREAS WITH SHADY TO PARTIALLY SHADY LAWNS. FOR ESTABLISHMENT IN HIGH QUALITY, INTENSIVELY MANAGED TURF AREA. MIXTURE INCLUDES: CERTIFIED KENTUCKY BLUEGRASS CULTIVARS 30 TO 40 PERCENT AND CERTIFIED FINE FESCUE 60 TO 70 PERCENT. SEEDING RATE: 1 1/2 TO 3 POUNDS PER 1000 SQUARE FEET.
NOTES:
SELECT TURFGRASS VARIETIES FROM THOSE LISTED IN THE MOST CURRENT UNIVERSITY OF MARYLAND PUBLICATION, AGRONOMY MEMO #77, "TURFGRASS CULTIVAR RECOMMENDATIONS FOR MARYLAND".
CHOOSE CERTIFIED MATERIAL. CERTIFIED MATERIAL IS THE BEST GUARANTEE OF CULTIVAR PURITY. THE CERTIFICATION PROGRAM OF THE MARYLAND DEPARTMENT OF AGRICULTURE, TURF AND SEED SECTION, PROVIDES A RELIABLE MEANS OF CONSUMER PROTECTION AND ASSURES A PURE GENETIC LINE.
3. IDEAL TIMES OF SEEDING FOR TURF GRASS MIXTURES
WESTERN MARYLAND: MARCH 15 TO JUNE 1, AUGUST 1 TO OCTOBER 1 (HARDNESS ZONES: 5B, 6A)
CENTRAL MARYLAND: MARCH 1 TO MAY 15, AUGUST 15 TO OCTOBER 15 (HARDNESS ZONE: 6B)
SOUTHERN MD, EASTERN SHORE: MARCH 1 TO MAY 15, AUGUST 15 TO OCTOBER 15 (HARDNESS ZONES: 7A, 7B)
4. TILL AREAS TO RECEIVE SEED BY DISKING OR OTHER APPROVED METHODS TO A DEPTH OF 2 TO 4 INCHES, LEVEL AND RAKE THE AREAS TO PREPARE A PROPER SEEDBED. REMOVE STONES AND DEBRIS OVER 1 1/2 INCHES IN DIAMETER. THE RESEED SEEDBEDS MUST BE IN SUCH CONDITION THAT FUTURE MOWING OF GRASSES WILL POSE NO DIFFICULTY.
5. IF SOIL MOISTURE IS DEFICIENT, SUPPLY NEW SEEDINGS WITH ADEQUATE WATER FOR PLANT GROWTH (1/2 TO 1 INCH EVERY 3 TO 4 DAYS DEPENDING ON SOIL TYPE) UNTIL THEY ARE FIRMLY ESTABLISHED. THIS IS ESPECIALLY TRUE WHEN SEEDINGS ARE MADE LATE IN THE PLANTING SEASON, IN ABNORMALLY DRY OR HOT SEASONS, OR ON ADVERSE SITES.

NO.	SPECIES	APPLICATION RATE(LB/AC)	SEEDING DATES	SEEDING DEPTHS	FERTILIZER RATE (10-20-20)			LIME RATE
					N	P ₂ O ₅	K ₂ O	
6	TALL FESCUE PERENNIAL RYEGRASS WHITE CLOVER	40 25 5	FEB. 15-APR 30 AUG. 15-OCT 31	1/2 1/2 1/2	45 LB/AC (1 LB/ 1000SF)	90 LB/AC (2 LB/ 1000SF)	2 TONS/AC (90 LB/ 1000 SF)	
	DEERTONGUE CANADA BIRD RYE REDTOP COMMON LESPEDEZA	20 1 1	FEB. 15-APR 30 MAY 1-MAY 31	1/2 1/2 1/2				

- B. SOD: TO PROVIDE QUICK COVER ON DISTURBED AREAS (2:1 GRADE OR FLATTER).
1. GENERAL SPECIFICATIONS
1.a. CLASS OF TURFGRASS SOD MUST BE MARYLAND STATE CERTIFIED. SOD LABELS MUST BE MADE AVAILABLE TO THE JOB FOREMAN AND INSPECTOR.
1.b. SOD MUST BE MACHINE CUT AT A UNIFORM SOIL THICKNESS OF 3/4 INCHES, THICKNESS MUST INCLUDE TOP TIME OF CUTTING. MEASUREMENT FOR TURFGRASS MUST BE TAKEN AT THE TIME OF CUTTING. BREAKEN PADS AND TORN OR UNEVEN EDGES WILL NOT BE ACCEPTABLE.
1.c. STANDARD SIZE SECTIONS OF SOD MUST BE STRONG ENOUGH TO SUPPORT THEIR OWN WEIGHT AND RETAIN THEIR SIZE AND SHAPE WHEN SUSPENDED

VERTICALLY WITH A FIRM GRASP ON THE UPPER 10 PERCENT OF THE SECTION.

1. SOD MUST NOT BE HARVESTED OR TRANSPLANTED WHEN MOISTURE CONTENT (EXCESSIVELY DRY OR WET) MAY ADVERSELY AFFECT ITS SURVIVAL.
1.a. SOD MUST BE HARVESTED, DELIVERED, AND INSTALLED WITHIN A PERIOD OF 36 HOURS. SOD NOT TRANSPLANTED WITHIN THIS PERIOD MUST BE APPROVED BY AN AGRONOMIST OR SOIL SCIENTIST PRIOR TO ITS INSTALLATION.
2. SOD INSTALLATION
2.a. DURING PERIODS OF EXCESSIVELY HIGH TEMPERATURE OR IN AREAS HAVING DRY SUBSOIL, LIGHTLY IRRIGATE THE SUBSOIL IMMEDIATELY PRIOR TO LAYING THE SOD.
2.b. LAY THE FIRST ROW OF SOD IN A STRAIGHT LINE WITH SUBSEQUENT ROWS PLACE PARALLEL TO IT AND TIGHTLY WEDGED AGAINST EACH OTHER. STAGGER LATERAL JOINTS TO PROMOTE MORE UNIFORM GROWTH AND STRENGTH. ENSURE THAT SOD IS NOT STRETCHED OR OVERLAPPED AND THAT ALL JOINTS ARE BUTTED TIGHT IN ORDER TO PREVENT VOIDS WHICH WOULD CAUSE AIR DRYING OF THE ROOTS.
2.c. WHEREVER POSSIBLE, LAY SOD WITH THE LONG EDGES PARALLEL TO THE CONTOUR AND WITH STAGGERING JOINTS. ROLL AND TAMP. PEG OR OTHERWISE SECURE THE SOD TO PREVENT SLIPPAGE ON SLOPES. ENSURE SOIL CONTACT EXISTS BETWEEN SOD ROOTS AND THE UNDERLYING SOIL SURFACE.
2.d. WATER THE SOD IMMEDIATELY FOLLOWING ROLLING AND TAMPING UNTIL THE UNDERSIDE OF THE NEW SOD PAD AND SOIL SURFACE BELOW THE SOD IS MOIST. COMPLETE THE OPERATION OF LAYING, TAMPING AND IRRIGATING FOR ANY PIECE OF SOD WITHIN EIGHT HOURS.
3. SOD MAINTENANCE
3.a. IN THE ABSENCE OF ADEQUATE RAINFALL, WATER DAILY DURING THE FIRST WEEK. MAINTAIN ADEQUATE MOISTURE CONTENT.
3.b. AFTER THE FIRST WEEK, SOD WATERING IS REQUIRED AS NECESSARY TO MAINTAIN ADEQUATE MOISTURE CONTENT.
3.c. DO NOT MOW UNTIL THE SOD IS FIRMLY ROOTED. NO MORE THAN 1/2 OF THE GRASS LEAF MUST BE REMOVED BY THE INITIAL CUTTING OR SUBSEQUENT CUTTINGS. MAINTAIN A GRASS HEIGHT OF AT LEAST 3 INCHES UNLESS OTHERWISE SPECIFIED.

B-4-8 STANDARDS AND SPECIFICATIONS FOR STOCKPILE AREAS

PRINTS ISSUED FOR:
REVIEW

REVISIONS

REV.#	DESCRIPTION	DATE
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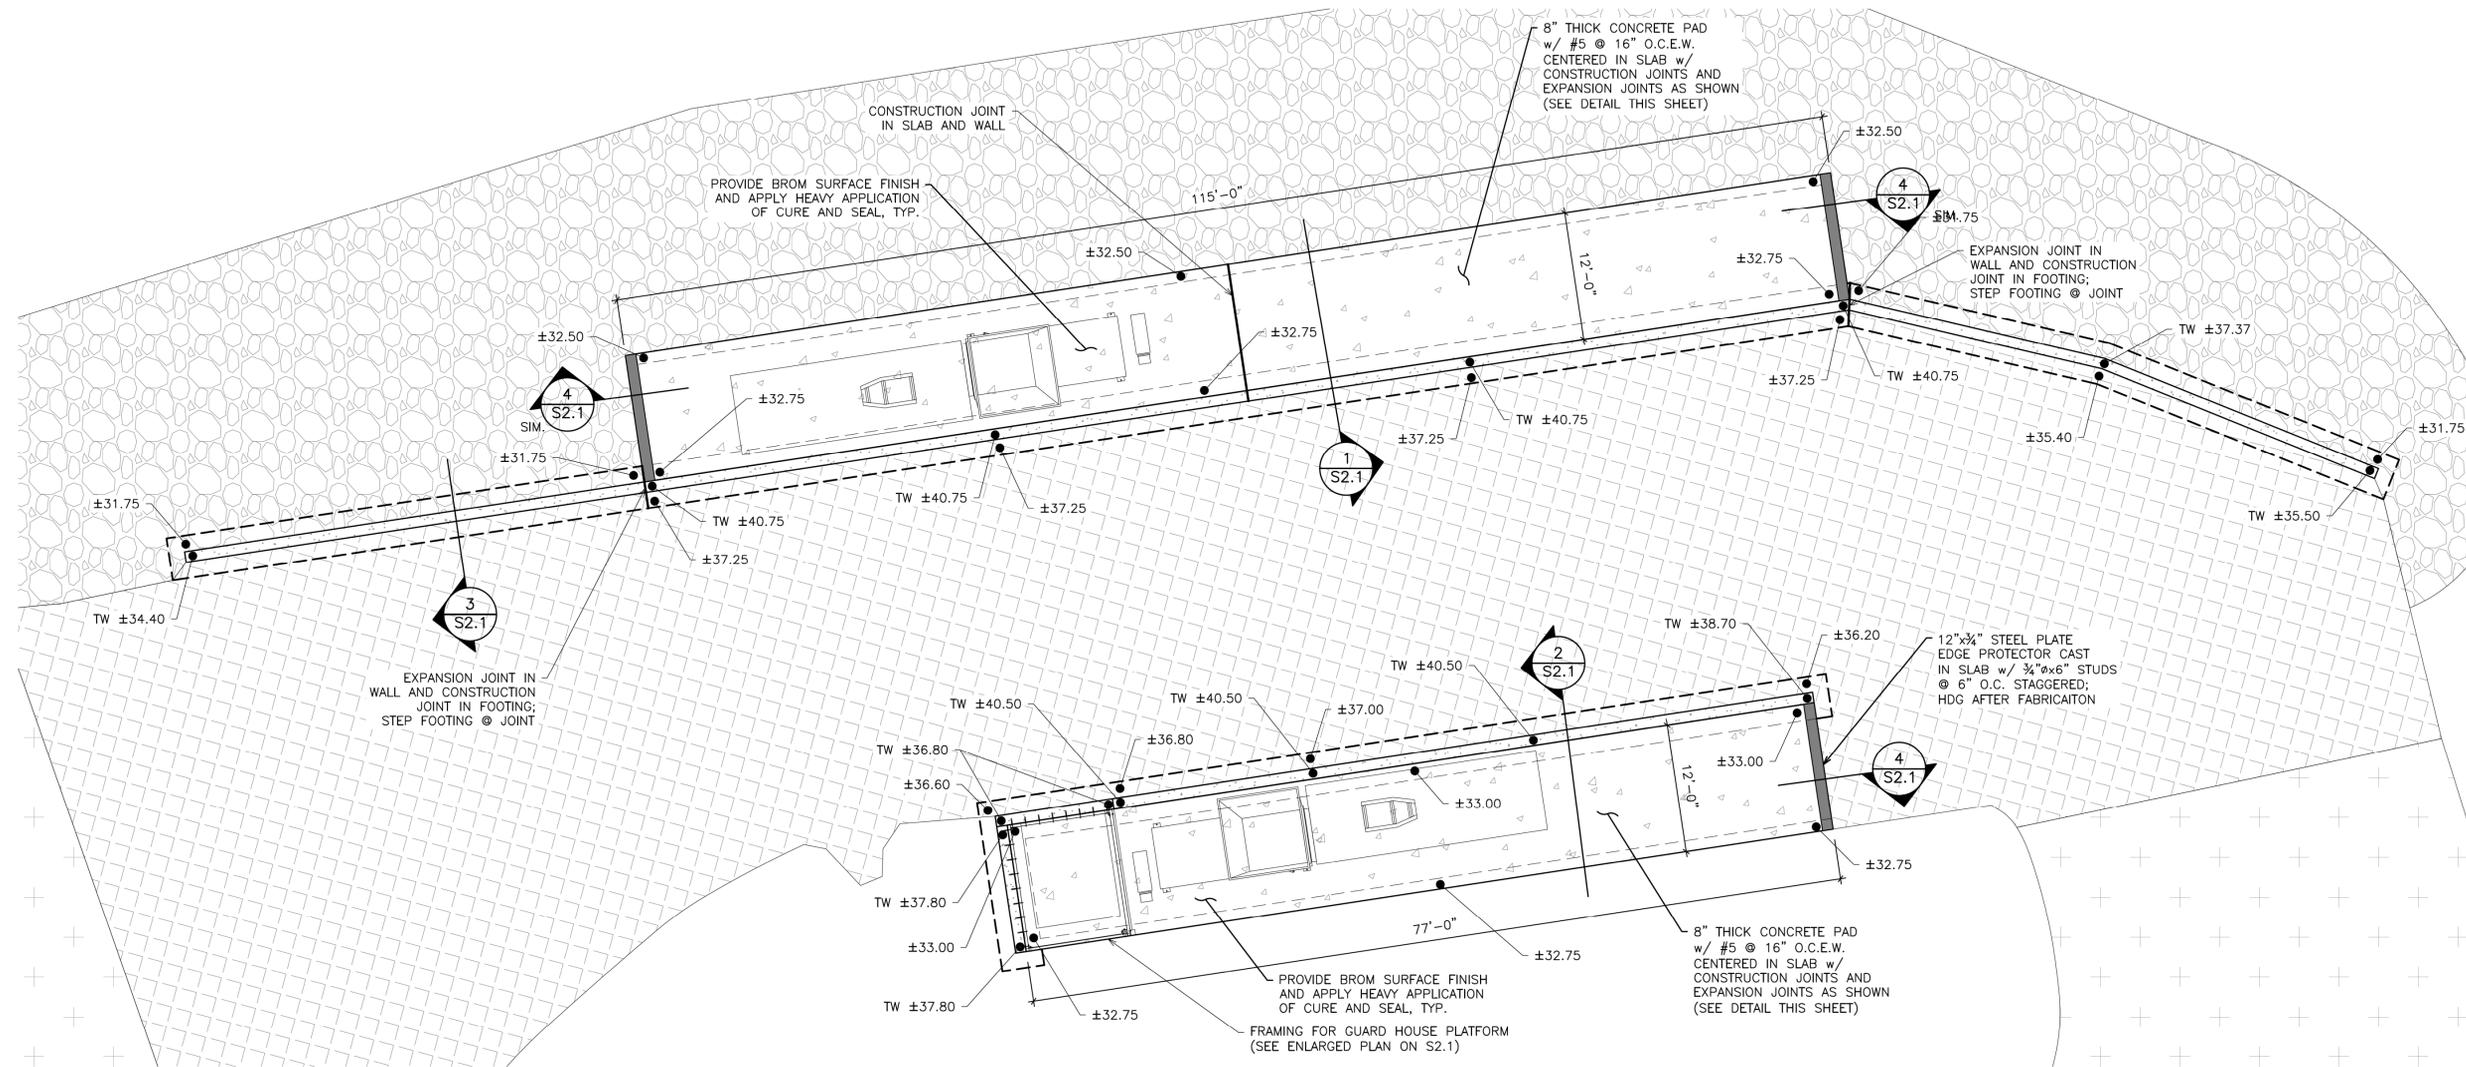
BERLIN HOMEOWNER
CONVENIENCE CENTER
BULKHEAD REPAIR
9696 MILL HAVEN ROAD
BERLIN, MD 21811



STRUCTURAL PLAN,
DETAILS, AND
NOTES

SCALE: AS NOTED SHEET NO.
DESIGN BY: ARM
DRAWN BY: TPT
CHECKED BY: ARM
GMB FILE: 240209
DATE: FEB 2025
S1.1

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FOUNDATION PLAN

SCALE: 1/8" = 1'-0"

NOTE:
1) COORDINATE ALL ELEVATIONS WITH CIVIL DRAWINGS

CAST-IN-PLACE CONCRETE

ALL CONCRETE SHALL BE MADE IN ACCORDANCE WITH DESIGN MIXES WHICH ARE TO BE APPROVED BY THE ENGINEER PRIOR TO CASTING ANY CONCRETE. MIXES SHALL BE IN ACCORDANCE WITH THE AMERICAN CONCRETE INSTITUTION ACI 318. MIXES SHALL HAVE A MINIMUM CEMENT CONTENT OF 520 LB. PER CUBIC YD., MAXIMUM WATER/CEMENT RATIO OF 0.53 FOR INTERIOR CONCRETE PROTECTED FROM FREEZING AND 0.45 FOR ALL EXTERIOR EXPOSED CONCRETE.

MINIMUM SPECIFIED COMPRESSIVE STRENGTH f'_c @ 28 DAYS.

LOCATION	MIN. COMP. (F'c)	SLUMP (IN.)	AIR ENTRAINED
SLABS AND WALLS	4000 PSI	4" +/- 1"	5% +/- 1%

FIBERMESH ADDITIVE ACCEPTABLE WITHIN MANUFACTURER RECOMMENDATIONS AND PER COUNTY.

CONCRETE MATERIALS SHALL CONFORM TO ASTM C150, TYPE I FOR PORTLAND CEMENT AND ASTM C33 FOR AGGREGATES. WATER-REDUCING ADMIXTURES SHALL CONFORM TO ASTM C494, TYPE A (FREE OF CALCIUM CHLORIDES), AIR-ENTRAINING ADMIXTURES SHALL CONFORM TO ASTM C266, AND HIGH-RANGE WATER REDUCERS (SUPER-PLASTICIZERS) SHALL CONFORM TO ASTM C494, TYPE F. FLY ASH SHALL COMPLY WITH ASTM C619 FOR CLASS F AND SHALL NOT BE PROPORTIONED IN MIXES WITH MORE THAN 20% CEMENT BY WEIGHT. LIQUID-MEMBRANE CURING COMPOUNDS SHALL BE HIGH-SOLIDS, WATER AND ACRYLIC-BASED, COMPLYING WITH ASTM C309 AS TESTED UNDER ASTM C156.

USE OF ADDITIVES CONTAINING CALCIUM CHLORIDE SHALL NOT BE PERMITTED. DO NOT USE HIGH-RANGE WATER REDUCING ADMIXTURES IN AIR-ENTRAINED CONCRETE. CONFORM TO ASTM C260.

ADDITION OF WATER TO THE CONCRETE AT THE JOB SITE FOR THE PURPOSE OF INCREASING THE SLUMP OR FOR RETEMPERING THE CONCRETE WHICH HAS BEGUN TO SET IS STRICTLY PROHIBITED.

THE CONTRACTOR SHALL BE RESPONSIBLE FOR FURNISHING AND INSTALLING ANCHOR BOLTS, CLIPS, INSERTS, CONNECTION PLATES, SLEEVES, SLOTS AND OTHER REQUIRED ITEMS IN ACCORDANCE WITH THE CONTRACT DRAWINGS, AND IN COOPERATION WITH OTHER TRADES PRIOR TO PLACING CONCRETE.

REINFORCING STEEL SHALL BE HIGH STRENGTH NEW BILLET STEEL CONFORMING TO ASTM A-615, GRADE 60 (60,000 PSI). WELDED WIRE FABRIC (WFF) SHALL CONFORM TO ASTM A-185. ALL REINFORCING SHALL BE DETAILED, FABRICATED, AND PLACED IN ACCORDANCE WITH ACSI MANUAL OF STANDARD PRACTICE FOR DETAILING CONCRETE STRUCTURES. (ACI-315). DETAILS OF REINFORCEMENT SHALL CONFORM TO ACI 318, ACI 315, AND CRSI STANDARDS.

ALL REINFORCING STEEL (INCLUDING WELDED WIRE FABRIC) SHALL BE SECURELY TIED AND ANCHORED IN PLACE TO PREVENT DISLOCATION DURING THE PLACING OPERATION.

REINFORCING STEEL SHALL BE CLEAN OF MUD, DEBRIS, LOOSE RUST, CEMENT, GROUT, OR ANY OTHER MATERIAL WHICH MAY INHIBIT THE BOND BETWEEN THE STEEL AND CONCRETE.

STEEL

ALL OTHER STRUCTURAL STEEL, INCLUDING PLATES, TIE RODS AND MISCELLANEOUS SHAPES SHALL CONFORM TO ASTM A36 (36 KSI).

BOLTS FOR CONNECTING STRUCTURAL STEEL SHAPES SHALL BE ASTM A325-N, 3/4 -INCH DIAMETER, UNLESS OTHERWISE NOTED ON THE DRAWINGS OR IN THE PROJECT SPECIFICATIONS.

OTHER BOLTS SHALL CONFORM TO ASTM F1554 GRADE 36.

FABRICATION AND ERECTION OF ALL STRUCTURAL STEEL SHALL BE IN ACCORDANCE WITH THE LATEST SPECIFICATION OF THE AMERICAN INSTITUTE OF STEEL CONSTRUCTION.

FOUNDATION

SLAB AND FOOTING SUBGRADE SHALL BE PREPARED PER SOIL REPORT BY SGI, LLC DATED SEPTEMBER 26, 2024 REQUIREMENTS WITH 3000 PSF ALLOWABLE BEARING CAPACITY.

TIMBER

ALL TIMBER SHALL BE #1 SYP TREATED TO 0.6pcf CCA (MIN.)

SHOP DRAWINGS

THE GENERAL CONTRACTOR SHALL SUBMIT SHOP DRAWINGS FOR ALL STRUCTURAL ELEMENTS SHOWN ON THE CONTRACT DOCUMENTS FOR APPROVAL. THE STRUCTURAL ENGINEER WILL NOT BE RESPONSIBLE FOR THE STRUCTURAL CERTIFICATION AND DESIGN OF THE PROJECT IF THE GENERAL CONTRACTOR FAILS TO OBTAIN APPROVAL OF THE SHOP DRAWINGS. THE GENERAL CONTRACTOR SHALL INFORM THE STRUCTURAL ENGINEER IN WRITING CONCERNING DEVIATIONS AND/OR OMISSIONS FROM THE CONTRACT DOCUMENTS AT THE TIME OF SHOP DRAWING SUBMISSION. THE GENERAL CONTRACTOR SHALL REVIEW ALL SHOP DRAWINGS AND SHALL MAKE ALL CORRECTIONS HE DEEMS NECESSARY BEFORE SUBMISSION. THE GENERAL CONTRACTOR SHALL STATE ON THE SHOP DRAWINGS THAT CONTRACT DOCUMENT REQUIREMENTS HAVE BEEN MET AND THAT ALL DIMENSIONS, CONDITIONS AND QUANTITIES HAVE BEEN REVIEWED AND VERIFIED AS SHOWN AND/OR CORRECTED ON THE SHOP DRAWINGS.

MISCELLANEOUS ITEMS

THE CONTRACTOR IS SOLELY RESPONSIBLE FOR ALL SAFETY REGULATIONS, PROGRAMS AND PRECAUTIONS RELATED TO ALL WORK ON THIS PROJECT AND FOR THE PROTECTION OF PERSONS AND PROPERTY EITHER ON OR ADJACENT TO THE PROJECT AND SHALL PROTECT SAME AGAINST INJURY, DAMAGE OR LOSS.

THE CONTRACTOR IS RESPONSIBLE FOR LIMITING THE AMOUNT OF CONSTRUCTION LOAD IMPOSED ON THE STRUCTURE. SUCH LOADS SHALL NOT EXCEED THE CAPACITY OF THE STRUCTURE AT ANY TIME.

THE STRUCTURE IS DESIGNED TO FUNCTION AS A UNIT UPON COMPLETION, AND ANY TEMPORARY BRACING OR SUPPORT REQUIRED TO ACCOMMODATE THE CONTRACTOR'S MEANS AND METHODS ARE THE RESPONSIBILITY OF THE CONTRACTOR.


STRUCTURAL DRAWINGS SHALL BE USED IN CONJUNCTION WITH THE SITE DRAWINGS, AND THE CONTRACTOR SHALL BE RESPONSIBLE FOR SEEING THAT THE WORK OF ALL TRADES IS COORDINATED WITH ADJACENT WORK.

THE CONTRACTOR SHALL BE RESPONSIBLE FOR DESIGNING, FURNISHING, ERECTING AND REMOVING ANY TEMPORARY SHORING AND BRACING DURING CONSTRUCTION.

SAFETY REGULATIONS SHALL BE STRICTLY FOLLOWED BY THE CONTRACTOR OR SUBCONTRACTOR DURING ALL TIMES OF WORK ON THIS PROJECT. THE ARCHITECT OR ENGINEER SHALL NOT HAVE CONTROL OR CHARGE OF, AND SHALL NOT BE RESPONSIBLE FOR CONSTRUCTION MEANS, METHODS, TECHNIQUES, SEQUENCES OR PROCEDURES, FOR SAFETY PRECAUTIONS AND PROGRAMS IN CONNECTION WITH THE WORK, FOR ACTS OF OMISSIONS OF THE CONTRACTOR, SUBCONTRACTORS, OR ANY OTHER PERSONS PERFORMING ANY OF THE WORK IN ACCORDANCE WITH THE CONTRACT DOCUMENTS.

ALL SPECIALTY BOLTS, INCLUDING EXPANSION TYPE AND EPOXY TYPE ANCHORS SHALL BE INSTALLED IN STRICT ACCORDANCE WITH THE MANUFACTURER'S PRINTED INSTRUCTIONS.

THE CONTRACTOR SHALL PROTECT FROM DAMAGES EXISTING BUILDING(S), OWNER EQUIPMENT, ROADS, WALKS AND UTILITIES. THE CONTRACTOR SHALL MAINTAIN THESE DURING THE COURSE OF THE WORK, AND SHALL REPAIR ALL DAMAGES AT NO ADDITIONAL EXPENSE TO THE OWNER.

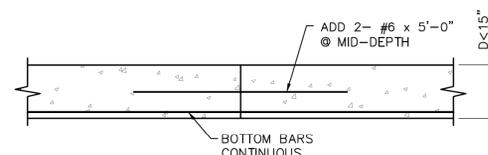

NOTE:
CONSTRUCTION JOINTS SHALL BE PLACED IN MIDDLE THIRD OF CLEAR SPAN. CONSTRUCTION JOINTS ARE NOT PERMITTED WITHIN 4'-0" OF OPENINGS

CONSTRUCTION JOINT DETAIL

N.T.S.




EXPANSION JOINT DETAIL

N.T.S.


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REVISIONS


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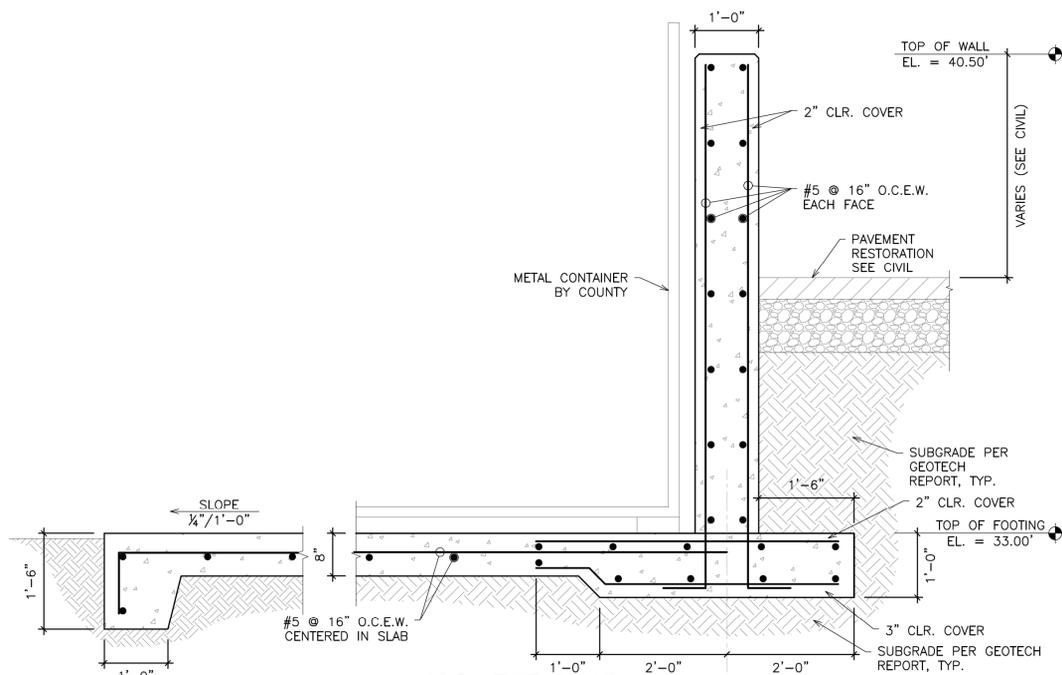
SECTION 1
SCALE: 3/4" = 1'-0"
S2.1

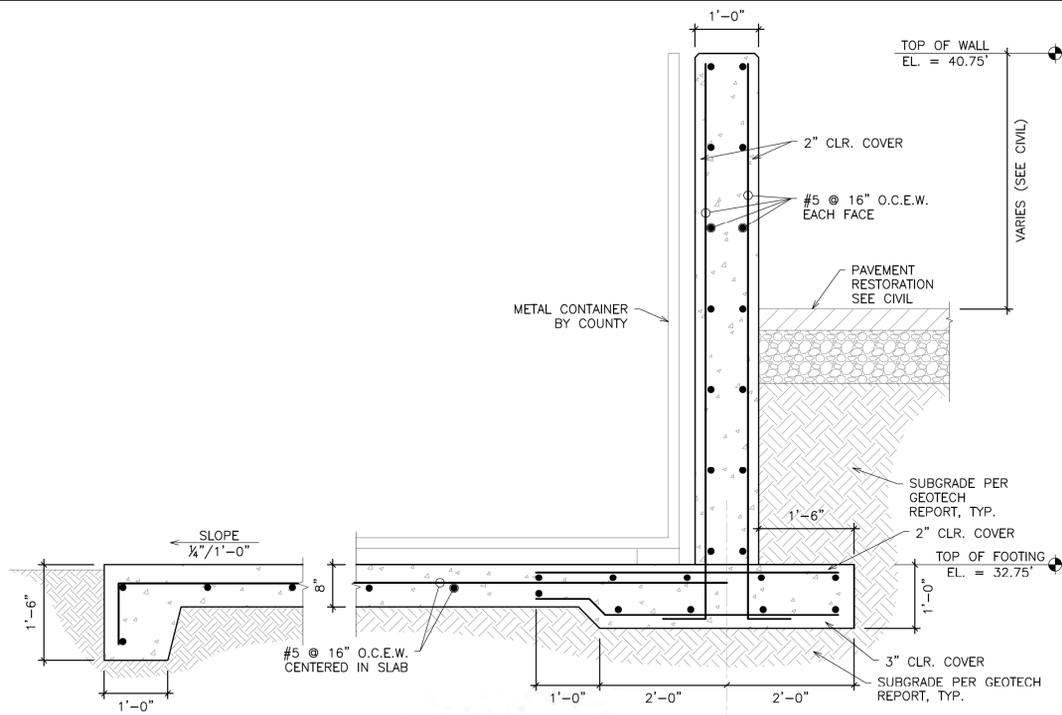


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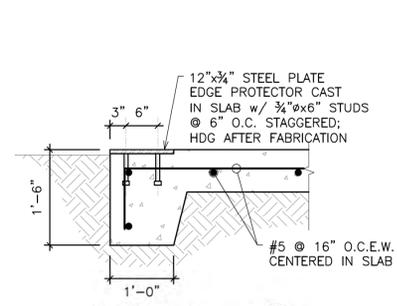
ENLARGED GUARD HOUSE PLATFORM PLAN
SCALE: 1/2" = 1'-0"
NOTE: TIMBER TREATMENT SHALL BE MIN. 0.6 CCA.

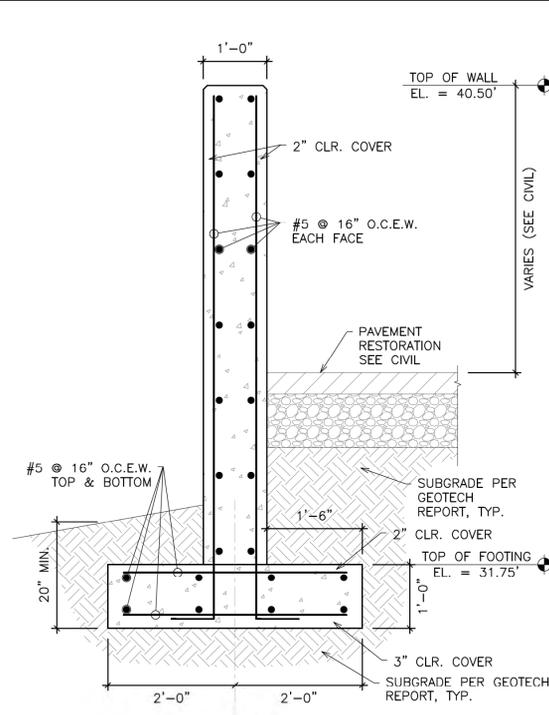


SECTION 2
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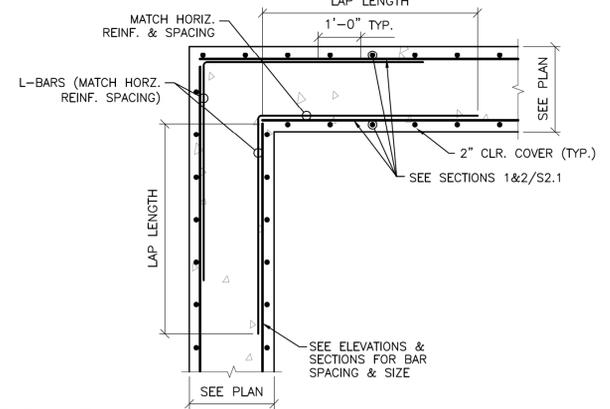
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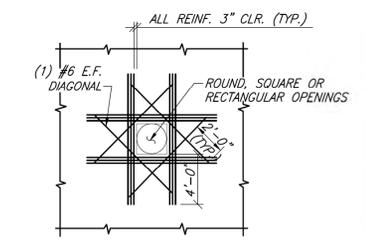
SECTION 4
SCALE: 3/4" = 1'-0"
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DECK BOARD ATTACHMENT DETAIL
N.T.S.

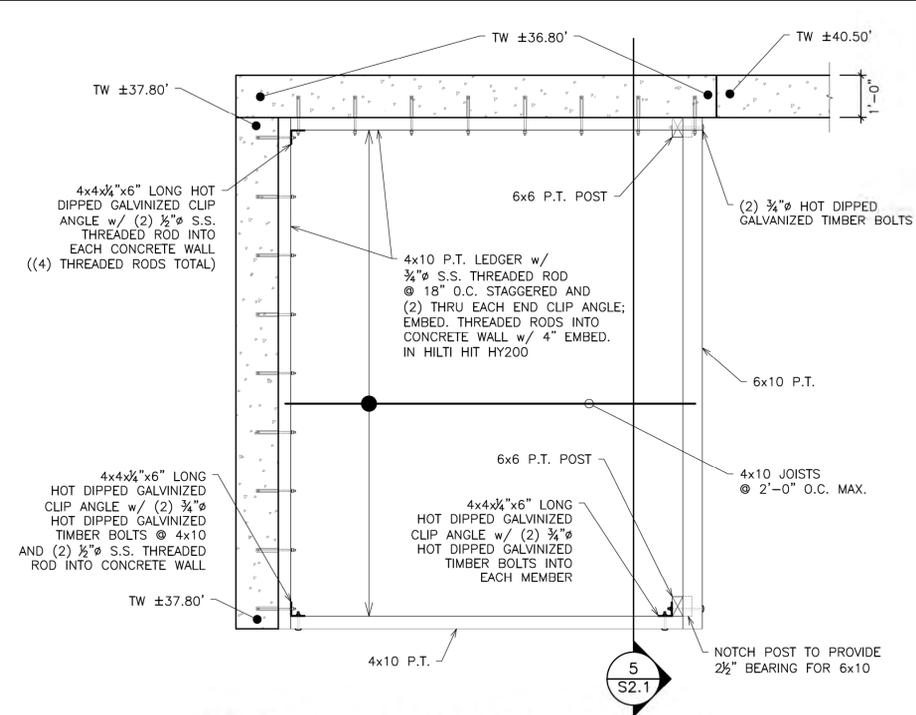

TYPICAL WALL CORNER REINFORCEMENT DETAIL
N.T.S.

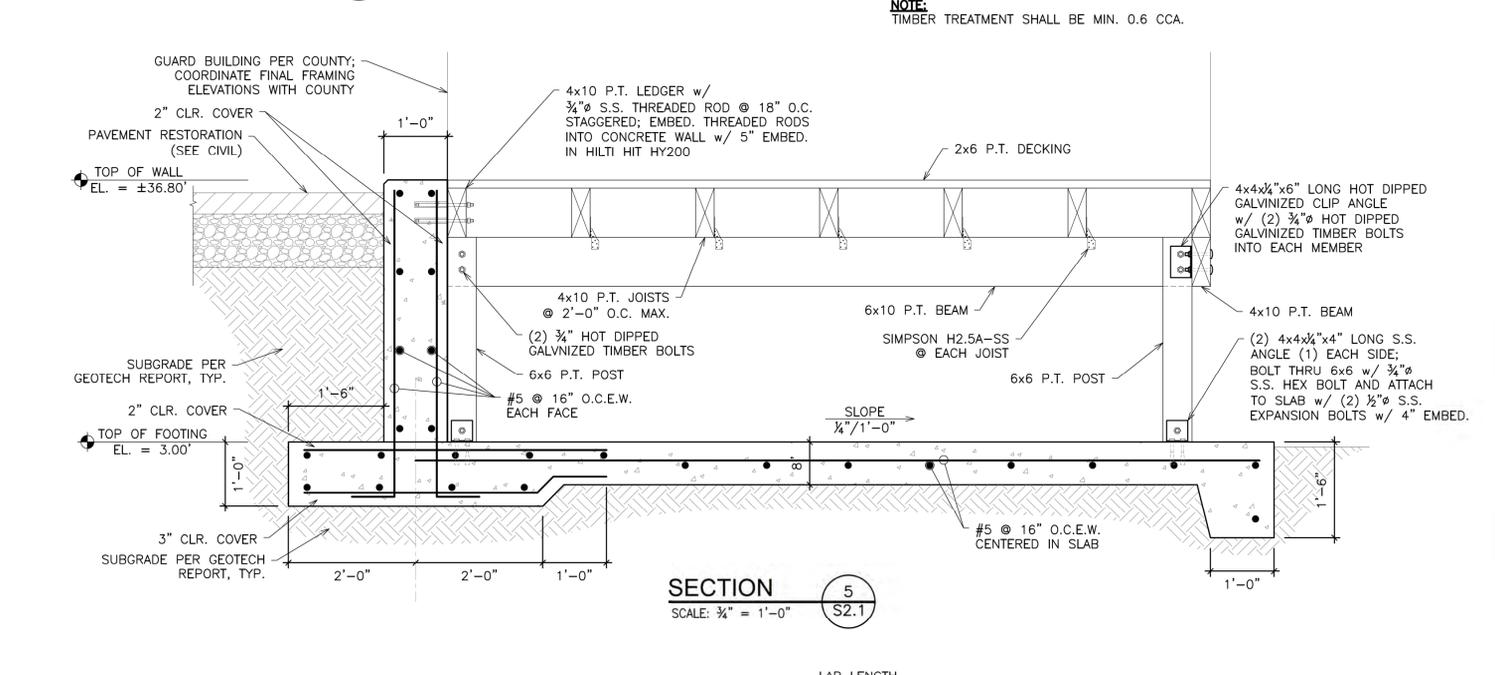

REBAR DETAIL @ OPENINGS
N.T.S.

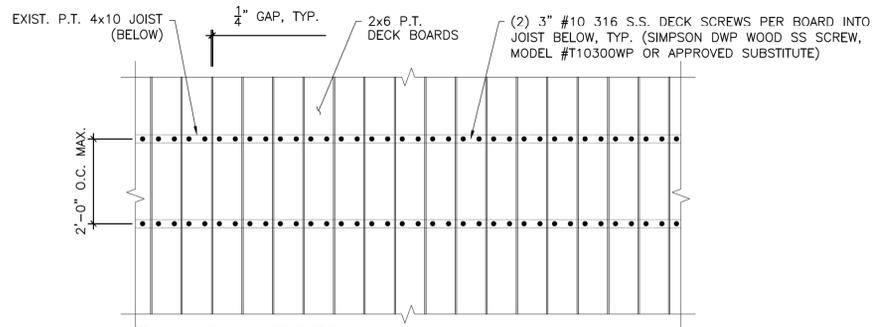- NOTE:
1. PROVIDE ADDITIONAL REINFORCING, (MINIMUM OF ONE-HALF THE NUMBER OF PRINCIPLE REINFORCING, BARS BEING INTERRUPTED BY THE OPENING AT EACH FACE ON EACH SIDE).
 2. FOR OPENINGS LESS THAN 12" DIA., NO ADDITIONAL REINFORCING IS REQUIRED PROVIDED, NO REINFORCING IS INTERRUPTED BY THE OPENING.

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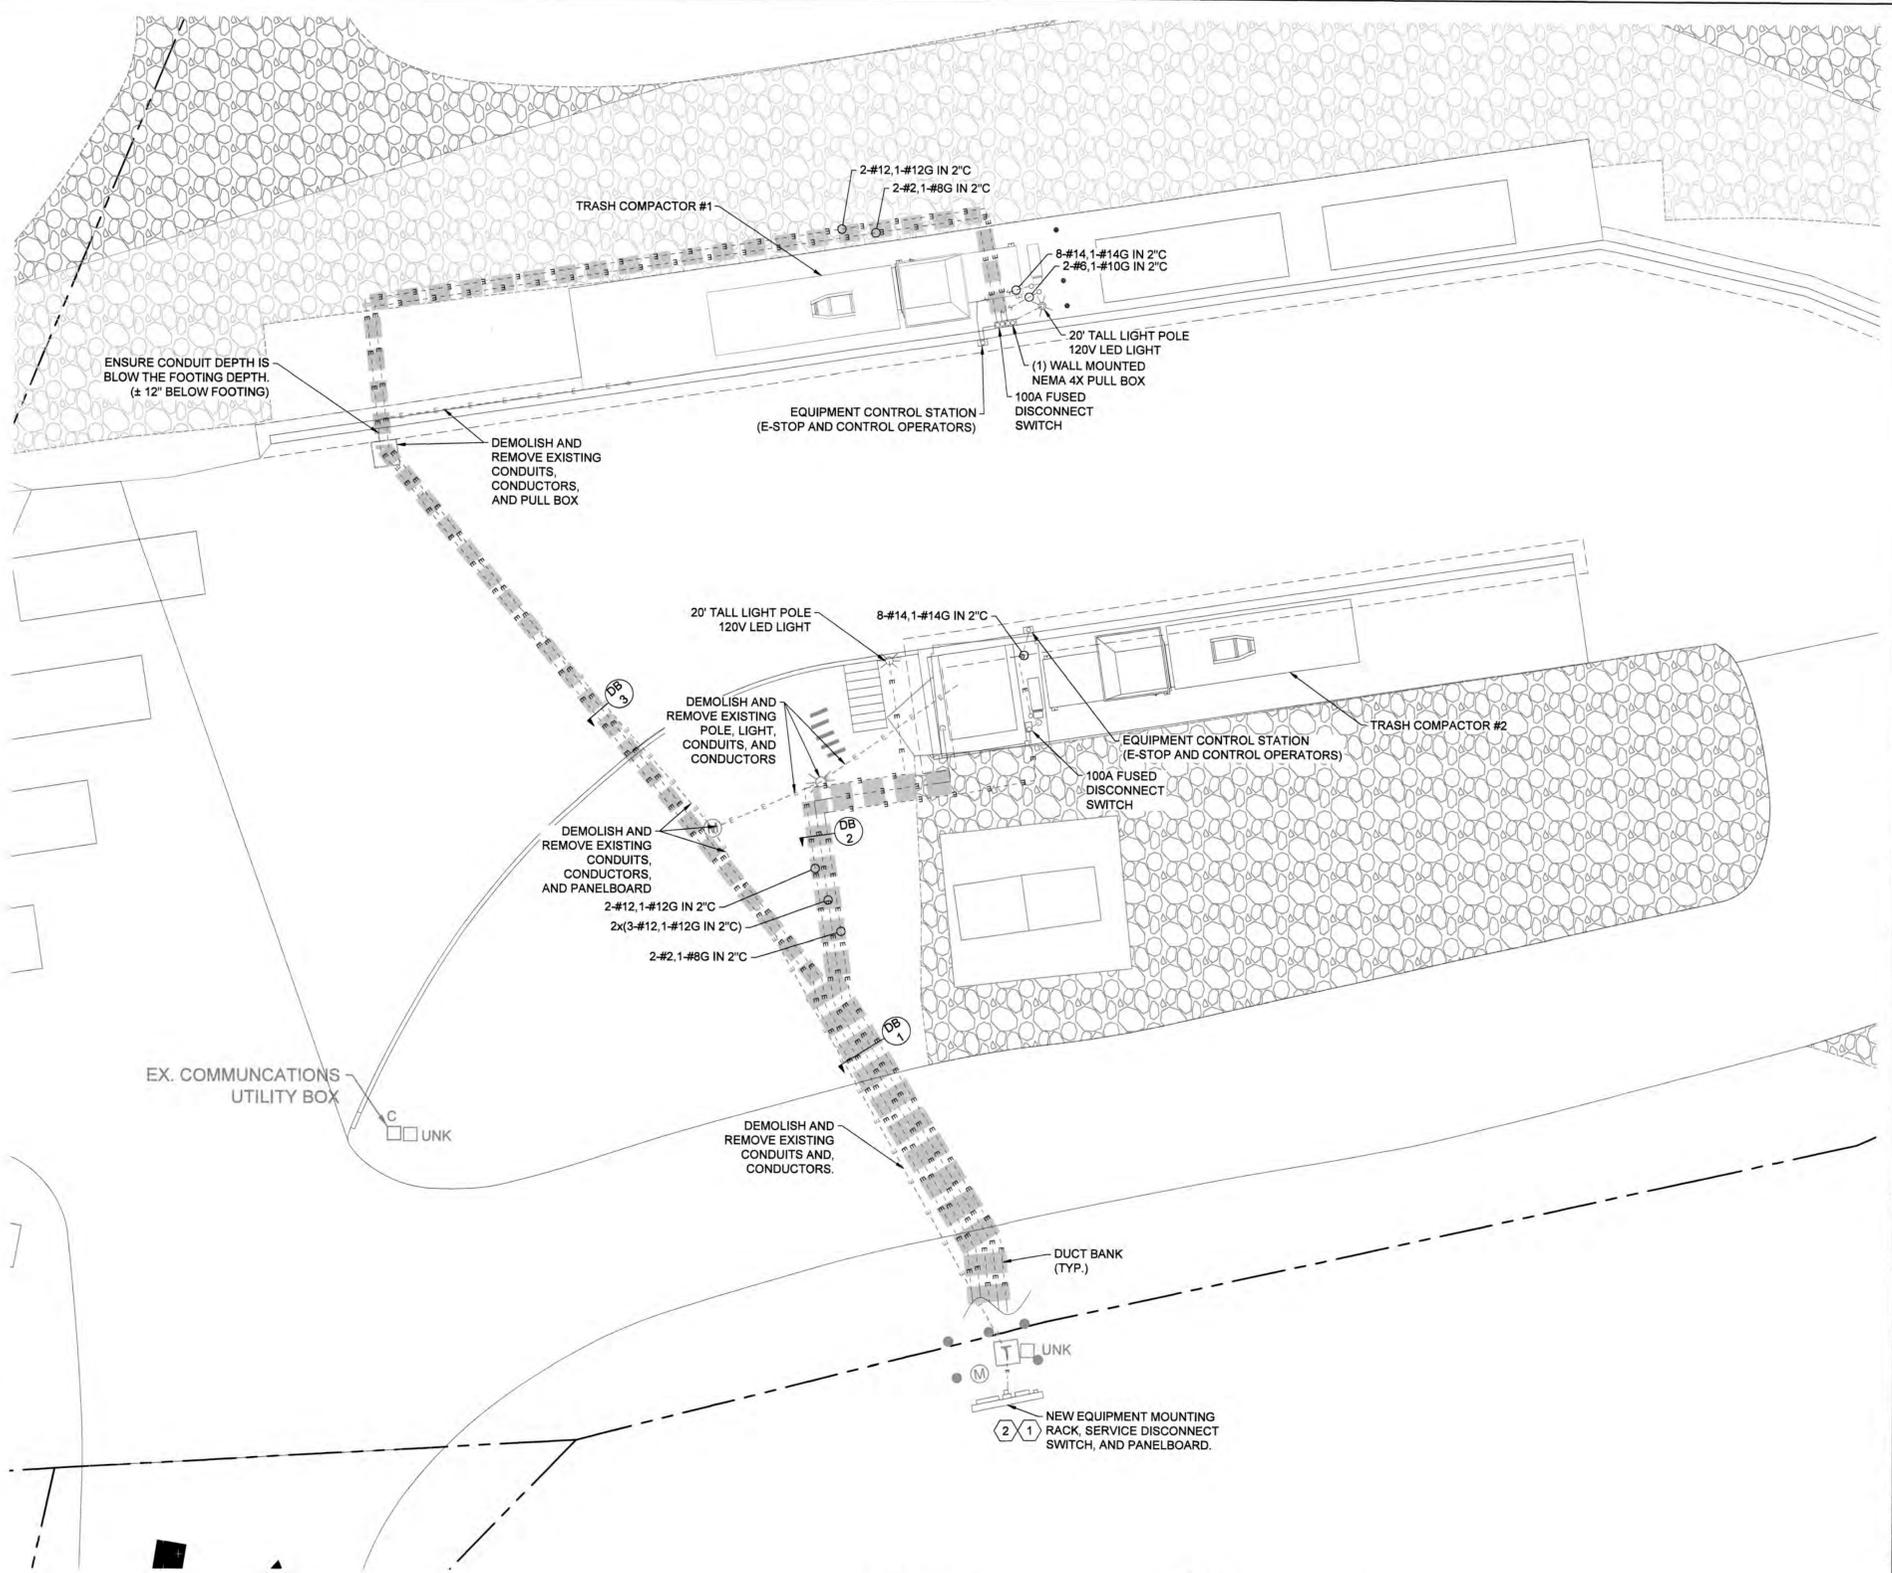
SECTIONS AND DETAILS

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DATE: FEB 2025	

ABBREVIATIONS		MAX	MAXIMUM
A	AMPERE	MCM	THOUSAND CIRCULAR MILS
AC	ALTERNATING CURRENT	MIN.	MINIMUM
APPROX.	APPROXIMATELY	MTG	MOUNTING
AT	AMPS TRIP	NEC	NATIONAL ELECTRICAL CODE
AWG	AMERICAN WIRE GAGE	NEMA	NATIONAL ELECTRICAL MANUFACTURERS ASSOCIATION
CB	CIRCUIT BREAKER	NFSS	NON-FUSED SAFETY SWITCH
CFR	CODE OF FEDERAL REGULATIONS	NO.	NUMBER
CKT, CIRC.	CIRCUIT	OL	OVERLOAD
CP, C.P.	CONTROL PANEL	PF-0	POWER FEEDER WITH SOURCE DESIGNATION AND CIRCUIT DESIGNATION
CPT	CONTROL POWER TRANSFORMER	PH	PHASE
DC	DIRECT CURRENT	PP-0	POWER PANELBOARD
DIA	DIAMETER	P-0	PUMP WITH DESIGNATION
D.S.	DISCONNECT SWITCH	SDBC	SOFT DRAWN BARE COPPER
DWG	DRAWING	S.E.	SERVICE ENTRANCE
ELEC	ELECTRICAL	SP	SURGE PROTECTOR
ENCL	ENCLOSURE	S.S.	STAINLESS STEEL
EX., EXIST	EXISTING	T-0	TRANSFORMER WITH DESIGNATION
G	EQUIPMENT GROUNDING CONDUCTOR OR GREEN	TSP	TWISTED SHIELDED PAIR
GRD	GROUND	TYP.	TYPICAL
HOA	HAND-OFF-AUTOMATIC	UTIL.	UTILITY
HZ	HERTZ	V	VOLT
JB, JB-0	JUNCTION BOX OR JUNCTION BOX WITH DESIGNATION	VAC	VOLTS ALTERNATING CURRENT
KCMIL	KILO (THOUSAND) CIRCULAR MILS	VFD	VARIABLE FREQUENCY DRIVE
KVA	KILOVOLT AMPERE	W	WITH
KW	KILOWATT	WWTP	WASTE WATER TREATMENT PLANT
LP	LIGHTING PANELBOARD	XFM	TRANSFORMER
M-0	MOTOR STARTER COIL WITH DESIGNATION		

LEGEND - PLANS & DETAILS	
SYMBOL	DESCRIPTION
---	CONDUIT EXPOSED
---	CONDUIT CONCEALED
---	CONDUIT DOWN
---	CONDUIT UP
---	CONDUIT CONTINUATION / BREAK LINE
⊙	CONDUIT BODY
⊠	JUNCTION BOX
⊙	MOTOR
---	ELECTRIC UGND LINE
?	CODED NOTE
LP#-# OR PP#-#	HOME RUN TO PANELBOARD
{ }	GROUP OF ITEMS
⊕	RECEPTACLE
⊙	LIGHT
---	DUCT BANK
DB #	DUCT BANK SECTION MARKER

- GENERAL NOTES**
- ALL WORK IS NEW UNLESS OTHERWISE NOTED AS EXISTING. FOR THE CONVENIENCE OF THE CONTRACTOR, ON DRAWINGS WHICH CONTAIN NEW AND EXISTING FEATURES, A DISTINCTION BETWEEN NEW AND EXISTING MATERIALS, EQUIPMENT, AND STRUCTURES HAS BEEN MADE BY LINE WEIGHT. HEAVY LINE WEIGHT REPRESENTS NEW FEATURES (OR WORK TO BE DONE ON EXISTING FEATURES) AND LIGHT LINE WEIGHT REPRESENTS EXISTING FEATURES.
 - INFORMATION FOR EXISTING UTILITIES IS FROM AVAILABLE RECORDS AND SHALL BE VERIFIED BY THE CONTRACTOR TO HIS OR HER SATISFACTION PRIOR TO CONSTRUCTION ACTIVITIES. CONTRACTOR SHALL TAKE PRECAUTIONS TO PROTECT EXISTING UTILITIES AND STRUCTURES AND ANY DAMAGE TO THEM SHALL BE REPAIRED IMMEDIATELY (WITHIN 24 HOURS) BY THE CONTRACTOR AT NO COST TO THE OWNER.
 - THE CONTRACTOR SHALL MAINTAIN ACCESS TO THE EXISTING HOMEOWNER DROPOFF FACILITY AT ALL TIMES TO ALLOW COUNTY OPERATIONS AND MAINTENANCE STAFF TO EXECUTE AND COMPLETE ROUTINE DUTIES.
 - ALL WORK SHALL COMPLY WITH APPLICABLE REQUIREMENTS OF THE NATIONAL ELECTRICAL CODE.
 - MATERIALS, DEVICES, APPLIANCES, FITTINGS, AND EQUIPMENT INSTALLED SHALL BE LISTED. ALL PRODUCTS SHALL BE USED ONLY IN THE MANNER IN WHICH THEY HAVE BEEN TESTED AND FOUND SUITABLE FOR THE INTENDED USE.
 - EQUIPMENT AND SYSTEMS SHALL BE BONDED AND GROUNDED IN ACCORDANCE WITH ARTICLE 250 OF THE NATIONAL ELECTRICAL CODE, APPLICABLE LOCAL CODES, THE ELECTRICAL UTILITY PROVIDER, AND THE MANUFACTURER'S RECOMMENDATIONS.
 - CONDUIT AND CONDUCTOR SIZES ARE BASED ON COPPER CONDUCTORS UNLESS SPECIFICALLY NOTED OTHERWISE.
 - VOLTAGE DROP CALCULATIONS ARE BASED ON CIRCUIT LOADS AND DISTANCES FOR THE CIRCUIT ROUTING AS SHOWN. IF ALTERNATE CIRCUIT ROUTING, LOADING, OR CONDUCTOR MATERIAL ARE USED, VERIFY THAT THE VOLTAGE DROP IS ACCEPTABLE.
 - UNLESS OTHERWISE NOTED, CONDUCTORS HAVE NOT BEEN DERATED FOR BUNDLING OF CONDUCTORS, OR SIZED FOR MULTIPLE CIRCUITS. IF MULTIPLE CIRCUITS ARE INSTALLED IN A SINGLE RACEWAY, DERATE THE CONDUCTOR AMPACITY IN ACCORDANCE WITH THE NATIONAL ELECTRICAL CODE, AND PROVIDE THE CORRECT CONDUCTOR AND CONDUIT SIZES.
 - THE CONSTRUCTION CODE REQUIREMENTS OF STATE, COUNTY, OR OTHER POLITICAL SUBDIVISION WHICH EXCEED THE REQUIREMENTS OF NATIONAL CODES, STANDARDS, AND APPROVING BODIES SHALL BE MET AND COMPLIED WITH.
 - THE INSTALLATION OF ALL EQUIPMENT SHALL BE IN ACCORDANCE WITH THE MANUFACTURER'S RECOMMENDATIONS, REQUIREMENTS, AND GUIDELINES AND SHALL CONFORM TO THE PARTICULAR APPLICATION INVOLVED, IN ACCORDANCE WITH DETAILS SHOWN ON THE DRAWINGS. INSTALLATION OF EQUIPMENT CONNECTIONS TO EQUIPMENT SHALL BE COMPLETE IN EVERY DETAIL IN ACCORDANCE WITH APPLICABLE AND ACCEPTED INDUSTRY STANDARDS AND PRACTICES. PRIOR TO ACCEPTANCE OF ALL OR ANY PART OF THE WORK, THE CONTRACTOR SHALL TEST EACH PIECE OF EQUIPMENT AND SUBMIT WRITTEN CERTIFICATION THAT IT HAS BEEN INSTALLED IN ACCORDANCE WITH THE MANUFACTURER'S REQUIREMENTS AND IS READY TO BEGIN OPERATION.





SITE PLAN INSET
SCALE: 1" = 10'

- NOTES:**
- INSTALL NEW EQUIPMENT MOUNTING RACK WITH SERVICE DISCONNECT SWITCH AND PANELBOARD TO REPLACE EXISTING PANELBOARD. COORDINATE THE FAULT INTERRUPTING CURRENT RATING OF THE SERVICE EQUIPMENT WITH CHOPTANK ELECTRIC.
 - EXISTING TRASH COMPACTOR #1 (EASTERN SIDE) SHALL REMAIN OPERATIONAL DURING THE CONSTRUCTION OF PHASE 1 (WESTERN SIDE). THE CONTRACTOR IS RESPONSIBLE FOR PROVIDING OR MAINTAINING SERVICE TO TRASH COMPACTOR #1 DURING PHASE 1 CONSTRUCTION ACTIVITIES INCLUSIVE OF THE CONSTRUCTION OF NEW ELECTRIC EQUIPMENT.



EA Engineering, Science, and Technology, Inc., PBC


11200 Racetrack Road, Unit A101
Ocean Pines, Maryland 21811
(410) 841-5341
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FULL SIZE PLOT: 24" x 36"

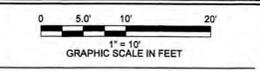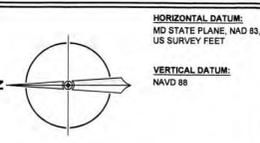REVISIONS

SEAL



PROFESSIONAL CERTIFICATION. I HEREBY CERTIFY THAT THESE DOCUMENTS WERE PREPARED OR APPROVED BY ME, AND THAT I AM A DULY LICENSED PROFESSIONAL ENGINEER UNDER THE LAWS OF THE STATE OF MARYLAND. LICENSE NO. 20812 EXPIRATION DATE: APRIL 24, 2027

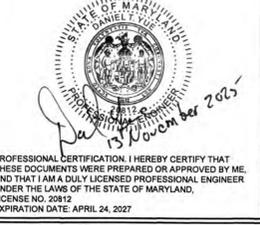PROJECT NAME
BERLIN HOMEOWNER CONVENIENCE CENTER BULKHEAD REPAIR

PROJECT ADDRESS
9696 MILL HAVEN ROAD
BERLIN, MD 21811

DRAWING TITLE
ELECTRICAL SITE PLAN, NOTES, ABBREVIATIONS, AND LEGEND

DRAWING INFORMATION
DRAWN BY: JWB DESIGNED BY: JWB/SCL
CHECKED BY: DOK PROJECT MANAGER: SCL
PROJECT NUMBER: 1060953

DRAWING NO.
E-101
DATE: NOVEMBER 2025 SHEET: 10 OF 11

FILE PATH: \\06AFINP\PROJECTS\2025\1060953 - BERLIN HOMEOWNER BULKHEAD REPAIR\DRAWINGS\1060953-07-10-ELECTRICAL\DWG\E-101\1060953-07-10-ELECTRICAL.DWG (PLOT: 11/20/2025 3:07 PM)

100% PLANS - FOR CONSTRUCTION

